

THE 746 JETT STREET RESIDENCES

746 JETT STREET, ATLANTA GA 30318

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PROJECT SUMMARY

NEW TWO STORY & ONE STORY SINGLE FAMILY HOUSE WITH FRONT & REAR PORCHES

HEATED SQUARE FOOTAGE FOR MAIN

FIRST FLOOR 800 SQFT 960 SQFT SEOND FLOOR 1760 SQFT

HEATED SQUARE FOOTAGE FOR ADU FIRST FLOOR 512 SQFT TOTAL HEATED 512 SQF

NON-HEATED SQUARE FOOTAGE FOR **EACH BUILDING** MAIN UNIT PORCHES 368 SQFT 368 SQFT TOTAL UNHEATED

STORIES **HEIGHT ACTUAL** 27'-6-1/4" HEIGHT ALLOWABLE 35'-0" COVERAGE ACTUAL 0.53 0.70 COVERAGE ALLOWABLE MIN REQ'D FENESTRATION 15% JETT ST FENESTRAION 17% FLOOD HAZARD NO TYPE DEAD LOADS: 10 PSF 40 PSF TYPE LIVE LOADS: TYPE ROOF LOADS: 20 PSF

PROJECT DESCRIPTION

ARCHITECT

TITLE THE 746 JETT STREET RESIDENCES

LOCATION ATLANTA, GA 30318

OWNER WESTSIDE ACQUISITIONS I, LLC

CONTACT: LEE HARROP

CONTACT: JULIE JU-YOUN KIM AIA

301.633.5920, JULIE.KIM@DESIGN.GATECH.EDU

CONTRACTOR OAKSATL

CONTACT: MATT MAXWELL

746 JETT STREET

404.793.2670, LEE@WESTSIDEFUTUREFUND.ORG

FLOURISHING COMMUNITIES COLLABORATIVE

404.964.5684, MATT.MAXWELL@OAKSATL.COM

GENERAL NOTES

1 IT IS THE RESPONSIBILITY OF THE GENERAL CONTRACTOR TO FIELD CHECK ALL DIMENSIONS AND CONDITIONS PRIOR TO AND DURING CONSTRUCTION

SYMBOLS LEGEND

LEVEL MARKER

SPOT ELEVATION


DETAIL PLAN CALLOUT

ELEVATION MARKER

A3-1

- 2 THE GENERAL CONTRACTOR SHALL COMPLY WITH AND GIVE NOTICES REQUIRED BY LAWS, ORDINANCES, RULES, REGULATIONS AND LAWFUL ORDERS OF PUBLIC AUTHORITIES BEARING ON PERFORMANCE OF THE WORK
- THE GENERAL CONTRACTOR SHALL AWARD SUBCONTRACTORS TO ENTITIES DULY LICENSED IN THE STATE OF 3 GEORGIA FOR THE WORK TO BE PERFORMED ON THIS PROJECT
- THE GENERAL CONTRACTOR SHALL SECURE AND PAY FOR THE BUILDING PERMIT AND OTHER PERMITS AND GOVERNMENTAL FEES, LICENSES AND INSPECTIONS NECESSARY FOR PROPER EXECUTION AND COMPLETION OF THIS WORK UNLESS OTHERWISE SPECIFIED BY THE OWNER
- THE USE OF THE SITE SHALL BE CONFINED TO THOSE AREAS APPROVED BY THE OWNER AND BUILDING INSPECTOR, IN ORDER TO MINIMIZE PUBLIC EXPOSURE TO UNSAFE CONDITIONS
- SHOULD ANY PORTION OF THESE DOCUMENTS BE AT VARIANCE WITH REQUIRED BUILDING CODES, ORDINANCES, OR OTHER PROVISIONS (NFPA, ADA, ETC.) THE CONTRACTOR SHALL IMMEDIATELY NOTIFY THE OWNER AND ARCHITECT FOR CONSTRUCTION CHANGE DIRECTIVES
- THE GENERAL CONTRACTOR SHALL BE RESPONSIBLE FOR THE PERMITTING, AND IMPLEMENTATION OF ALL ELECTRICAL, MECHANICAL, AND PLUMBING SERVICES FOR THIS PROJECT. THE GENERAL CONTRACTOR SHALL COORDINATE ALL EXISTING AND NEW SERVICES WITH THE OWNER

8	The general contractor shall abide by the following International Building Codes
	International Building Code, 2018 Edition, with Georgia Amendments (2020), (2022)
	International Residential Code, 2018 Edition, with Georgia Amendments (2020)
	International Fire Code, 2018 Edition (Contact State Fire Marshal Below)
	International Plumbing Code, 2018 Edition, with Georgia Amendments (2020), (2022)
	International Mechanical Code, 2018 Edition, with Georgia Amendments (2020)
	International Fuel Gas Code, 2018 Edition, with Georgia Amendments (2020), (2022)
	National Electrical Code, 2020 Edition, with Georgia Amendments (2021)
	International Energy Conservation Code, 2015 Edition, with Georgia Supplements and Amendments (2020), (2022)
	International Swimming Pool and Spa Code, 2018 Edition, with Georgia Amendments (2020)
	NFPA 101 Life Safety Code 2018 Edition, with State Amendments (2020) - (Effective January 1, 2020)

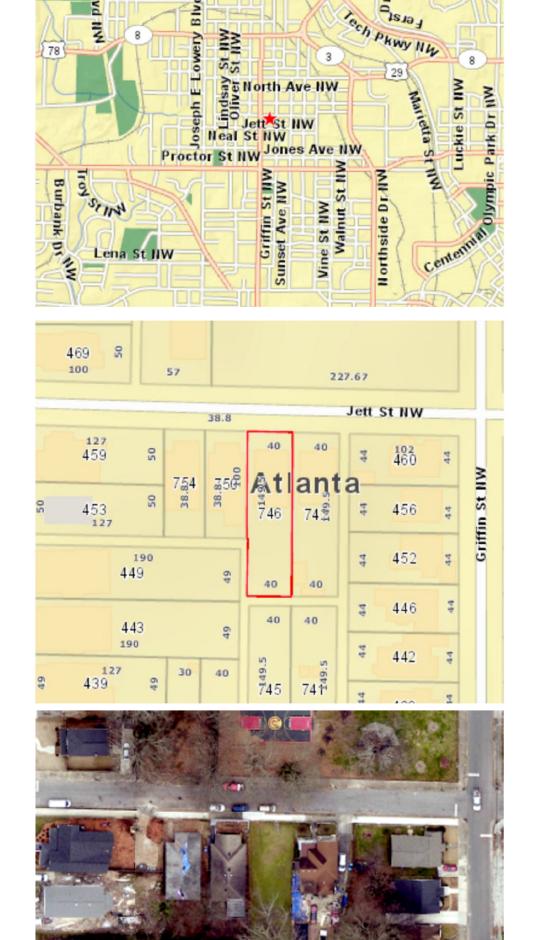

BEFORE STARTING ANY LAND-DISTURBING ACTIVITIES, THE CONTRACTOR IS REQUIRED TO SCHEDULE A PRE-CONSTRUCTION MEETING WITH EROSION & SEDIMENT CONTROL. CALL (404) 546 -1305 FAILURE TO SCHEDULE MAY RESULT IN A STOP WORK ORDER OR PERMIT REVOCATION.

IF YOU DIG GEORGIA, CALL UTILITIES PROTECTION CENTER 811. 1-800-282-7411 FIRST, IT'S THE LAW.

SECTION V - EROSION CONTROL CITY OF ATLANTA

1. THE ESCAPE OF SEDIMENT FROM THE SITE SHALL BE PREVENTED BY THE INSTALLATION OF EROSION AND SEDIMENT CONTROL MEASURES PRIOR TO OR CONCURRENT WITH LAND-DISTURBING ACTIVITIES

2. EROSION CONTROL MEASURES WILL BE MAINTAINED AT ALL TIMES. IF FULL IMPLEMENTATION OF THE APPROVED PLAN DOES NOT PROVIDE FOR EFFECTIVE EROSION CONTROL, ADDITIONAL EROSION AND SEDIMENT CONTROL MEASURES SHALL BE IMPLEMENTED TO CONTROL OR TREAT THE SEDIMENT SOURCE. 3. DISTURBED AREAS LEFT IDLE 14 DAYS SHALL BE STABILIZED WITH TEMPORARY VEGETATION AND MULCH: DISTURBED AREAS REMAINING IDLE 30 DAYS SHALL BE STABILIZED WITH PERMANENT VEGETATION.

4. EROSION AND SEDIMENT CONTROL MEASURES SHALL BE INSPECTED AT LEAST WEEKLY, AFTER EACH RAIN, AND REPAIRED AS NECESSARY

5. ADDITIONAL EROSION AND SEDIMENT CONTROL MEASURES SHALL BE INSTALLED IF DETERMINED NECESSARY BY ON-SITE INSPECTION.

6. SILT FENCE SHALL BE "TYPE S: AS PER THE MANUAL FOR EROSION AND SEDIMENT CONTROL IN GEORGIA AND BE WIRE REINFORCED (SEE ATTACHED DETAIL).

ROOT PROTECTION NOTES

1. MINIMAL USE OF MACHINERY AROUND ROOT ZONE TO BE PRACTICED HAND PRUNE ANY ROOTS ENCOUNTERED DURING FOUNDATION EXCAVATION

2. PRUNING TO TREES MUST CONFORM TO ANSI A300 **STANDARDS**

7. NO FOOTINGS IN THE STRUCTURAL ROOT PLATE

3. NO REMOVAL OF MORE THAN 20% OF LIVE CROWN 4. NO CUTS TO CREATE A LOP-SIDED CONDITIONI 5. PROVIDE 18" MULCH BED AROUND STRUCTURAL ROOT PLATE 6. PROVIDE 1/2" PLYWOOD SHEETS ON GRADE TO CREATE PATHWAY FOR MEN AND MATERIAL TRANSPORT

NEW TREES PLANTED: (IF APPLICABLE)

1. ALL TRESS WILL BE 2.5 CALIPERS 2. EACH UNDERSTORY TREE IS PLACED AT LEAST 15 FEET ON CENTER AWAY FROM ALL EXISTING AND PLANNED UNDERSTORY

3. EACH MIDSTORY TREE IS PLACED AT LEAST 25 FEET ON CENTER AWAY FROM ALL EXISTING AND PLANNED MIDSTORY

4. EACH OVERSTORY TREE IS PLACED AT LEAST 35 FEET ON CENTER AWAY FROM ALL EXISTING AND PLANNED OVERSTORY

SOIL PROTECTION & PREPARATION FOR GREEN INFRASTRUCTURE / STORMWATER MANAGEMENT SYSTEM **INSTALLATION**

1. DURING EXCAVATION, HEAVY MACHINERY SHALL NOT DRIVE OVER EXPOSED UNDERLYING SOILS

2. USE TRACKED OR LOW GROUND PRESSURE VEHICLES 3. EXCAVATE FINAL 9"-12" WITH TEETH OF BUCKET (DO NOT

4. SUBSOILS SHALL BE SCARIFIED (NOT COMPACTED) PRIOR TO PLACEMENT OF SLEAN WASHED DRAINAGE STONE

CONSTRUCTION STEPS:

1. REVIEW POTENTIAL PAVER AREAS AND LAYOUT, PAVERS SHOULD SLOPE LESS THAN 6% AWAY FROM THE STRUCTURE AND SHOULD NOT BE LOCATED: (1) ABOVE AN AREA WITH WATER TABLE OR BEDROCK LESS THAN TWO FEET BELOW THE TRENCH BOTTOM; (2) OVER OTHER UTILITY LINES; OR, (3) ABOVE A SEPTIC FIELD.

2. MEASURE THE AREA DRAINING TO THE PAVERS AND DETERMINE REQUIRED PAVER AREA FROM THE TABLE ON THE NEXT PAGE BASED ON THE SOIL DEPTH OF THE LOWER STONE STORAGE LAYER.

3. IF SOIL IS A CONCERN PERFORM INFILTRATION TEST ACCORDING TO APPENDIX A. IF THE RATE IS LESS THAN 0.25 IN/HR THIS METHOD CANNOT BE USED. IF THE RATE IS MORE THAN 0.50 IN/HR THE PAVE AREA MAY BE DECREASED 10% FOR EVERY 0.50 IN/HR INFILTRATION RATE INCREASE ABOVE 0.50

4. EXCAVATE AREA TO APPROPRIATE DEPTH AND SCARIFY SOIL TO 3'-4".


5. PLACE LEVEL AND COMPACT GRAVEL TO PLANNED DEPTH IN NO MORE THAN 6" LIFTS. THREE INCH MINIMUM DEPTH. 6. PLACE LEVEL AND COMPACT #8 STONE OR PEA GRAVEL BEDDING LAYER. TWO INCH MINIMUM DEPTH.

7. LAY PAVING STONE ONE AT A TIME OR USING MECHANICAL PLACEMENT AS APPLICABLE. CUT STONE AT EDGES TO FIT. 8. INSTALL EDGE RESTRAINTS PER MANUFACTURER'S SPECIFICATIONS.

9. SWEEP MORE #8 STONE OR PEA GRAVEL INTO STONE JOINTS UNTIL FILLED EVEN.

10. CUT AND ROUTE DOWNSPOUTS OR OTHER RAINWATER DELIVERY COMPONENTS. LEAF SCREEN OPTION(S) CHOSEN (CIRCLE SELECTED OPTIONS IN PRETREATMENT OPTIONS DETAIL FIGURE). STRAP AND SUPPORT AS NEEDED

CIRCLE ONE OR MORE OPTIONS USED A B C D

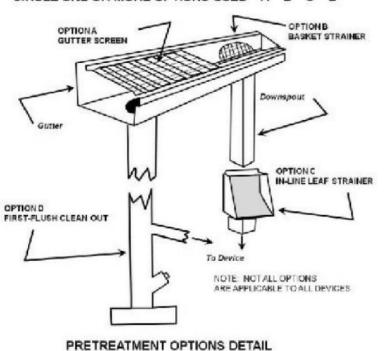


MAITENANCE:

1. REMOVE ACCUMULATED SEDIMENT AND DEBRIS FROM JOINT SPACE MONTHLY.

2. OBSERVE THE PERMEABLE PAVER SYSTEM FOR EXCESSIVE PONDING DURING STORM EVENTS AND REPAIR AS NEEDED 3. VACUUM, SWEEP, OR BLOW PERMEABLE PAVER SURFACE QUARTERLY TO KEEP THE SURFACE FREE OF SEDIMENT. NEW STONE MAY NEED TO BE SWEPT INTO THE JOINTS AS NEEDED 4. INSPECT PERMEABLE PAVER SURFACE FOR DETERIORATION ANNUALLY. REPAIR OR REPLACE ANY DAMAGED AREAS AS NEEDED.


SIZING CALCULATION: CONTRIBUTING DEPTH OF LOWER STONE STORAGE LAYER (INCHES) DRAINAGE AREA (SQUARE FEET) AREA OF PAVERS (SQUARE FEET 54 280 200 140 1000 550 400 390 2000 1090 920 780 1020 820 3000 1630 1360 4000 1090 2180 1810 1560 1360 5000 2270 1940 1700 1360 MEASURE CONTRIBUTING DRAINAGE AREA & READ AREA FOR GIVEN MEDIA DEPTH. CONTRIBUTING DRAINAGE AREA = 2307 SQFT

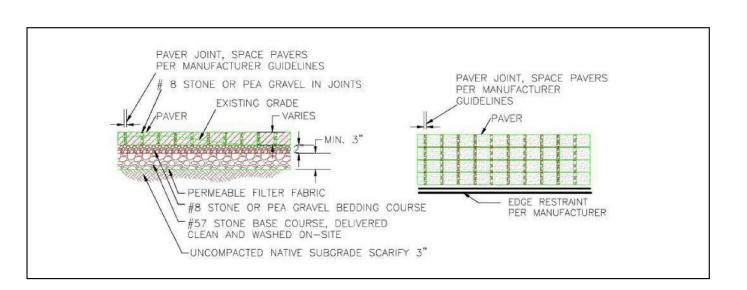



8 INCHES


DEPTH OF STONE MEDIA =

PAVER AREA = <u>844</u>

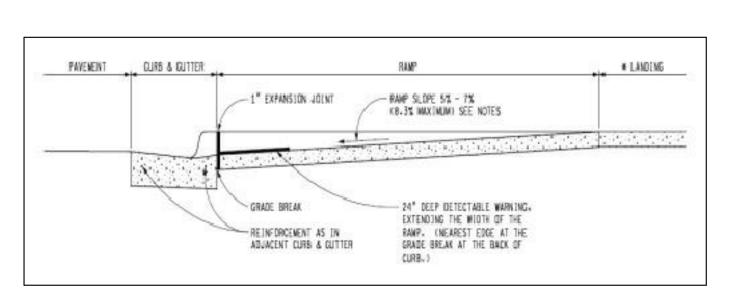

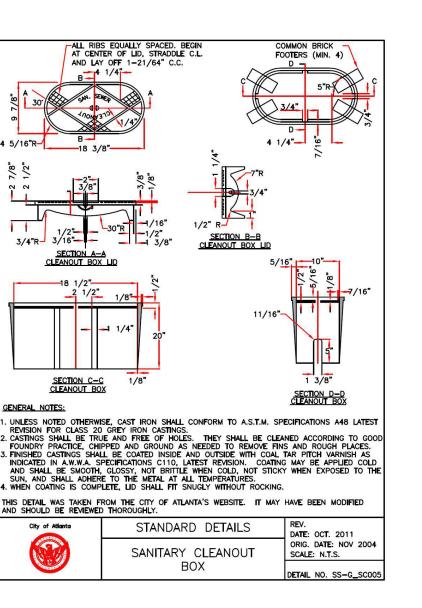

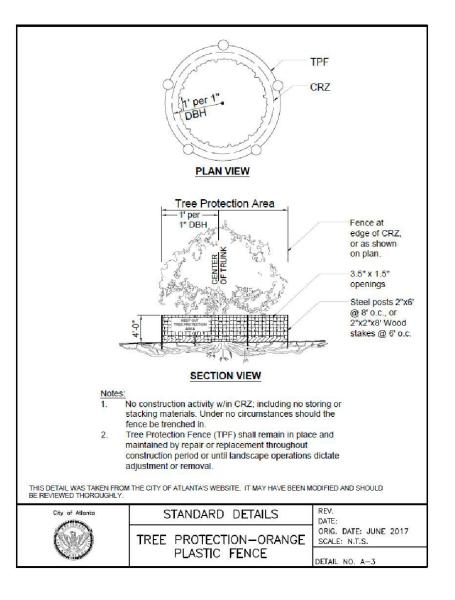


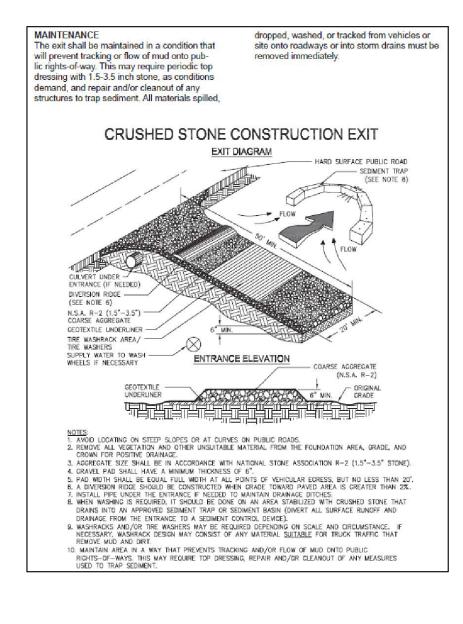

LAND LOT 111

FULTON COUNTY, GEORGIA

LOCATED IN ATLANTA

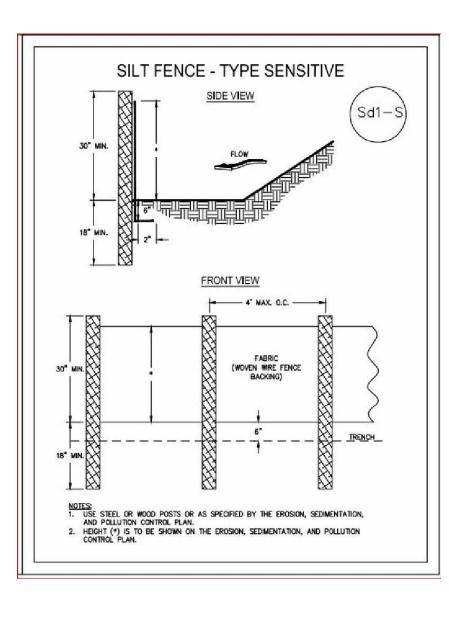

NO DETERMINATION OF FLOOD HAZARD HAS BEEN MADE FOR THIS PROPERTY BY THIS SURVEYOR. * L E G E N D * NOTE: ALL ITEMS IN THIS LEGEND MAY NOT APPEAR ON THIS PLAT. AKA ALSO KNOWN AS N/F NOW OR FORMERLY APD AS PER DEED NAIL NAIL FOUND APP AS PER PLAT PLAT (BOOK/PAGE) BSL BUILDING (SETBACK) LINE POB POINT OF BEGINNING CP COMPUTED POINT POC POINT OF COMMENCEMENT CTP CRIMP TOP PIPE FOUND RADIUS LENGTH DEED (BOOK/PAGE) R/W RIGHT-OF-WAY DW DRIVEWAY REINFORCING BAR FOUND EP EDGE OF PAVEMENT (1/2" UNO)FFE FINISH FLOOR ELEVATION RBS 1/2" REINFORCING BAR SET FKA FORMERLY KNOWN AS

SIDEWALK

-X- FENCE LINE

WALL

SANITARY SEWER EASEMENT

SSCO SANITARY SEWER CLEANOUT

FLOURISHING

COMMUNITIES

COLLABORATIVE

NOTES:

42" OAK DETERMINED TO BE DDH, WILL BE REMOVED. PERMIT NUMBER: BA-202202648

IPF IRON PIN FOUND

ARC LENGTH

LLL LAND LOT LINE

N NEIGHBOR'S

LL LAND LOT

EXISTING UNSAFE SITE WALLS & ~ THIS MAP/PLAT HAS BEEN FIELD RUN WITH ASSUMED ELEVATIONS. THEN ADJUSTED TO NAVD 88 BASED ON STEPS TO BE DEMOLISHED

NOTE: ANY & ALL UNDERGROUND UTILITIES, I.E. SEWER, STORM, GAS, WATER, ETC., HAVE NOT BEEN FIELD LOCATED BY CONVENTIONAL SURVEY METHODS.

ALL MATTERS OF TITLE ARE EXCEPTED. THIS PLAT

NOTE: PROPERTY LINES SHOWN ON THIS MAP/PLAT

FOUND, OLD & ESTABLISHED FENCE LINES, OLD WALL

FROM EVIDENCE FOUND AT THE APPLICABLE COUNTY

COURTHOUSE. THEY MAY ALSO DIFFER FROM OTHER

OPINION ON ALL PROPERTIES, INCLUDING ADJACENT

AND CONTIGUOUS PROPERTIES MAY BE NEEDED TO

RESOLVE ALL POSSIBLE PROPERTY LINE DISPUTES OR

THIS MAP/PLAT WAS MADE WITHOUT THE BENEFIT OF

BURDEN THIS PROPERTY. THIS MAP/PLAT IS SUBJECT

CONTENTION WITH OR DIFFER FROM INTERPRETATIONS

OBLIGATION TO CONFIRM WITH PERMITTING AGENCIES

BASED ON THEIR SPECIFIC CONSTRUCTION PROJECTS.

TO REVISIONS AND UPDATE UPON RECEIPT OF SAID

A CURRENT TITLE COMMITMENT, EASEMENTS AND

ENCUMBRANCES MAY EXIST WHICH BENEFIT AND

BUILDING LINES SHOWN HEREON DERIVED FROM

OF GOVERNING AUTHORITIES. IT IS THE CLIENT'S

MULTIPLE OBSERVATIONS FROM GOOGLE EARTH

SATELLITE IMAGERY OR OTHER ONLINE SOURCES.

THE ELEVATIONS SHOWN HEREON ARE $\pm /-1$ (\pm ONE

VARIOUS ONLINE SOURCES. THEY MAY BE IN

EVIDENCE OF APPARENT POSSESSION (IRON PINS

LINES, SHRUB & HEDGE LINE, HOUSE LOCATIONS,

ETC.) THEY MAY DIFFER AND BE IN CONTENTION

IS SUBJECT TO ALL LEGAL EASEMENTS AND

REPRESENT PHYSICAL FIELD CONDITIONS BY


SURVEYOR OPINIONS AND/OR NEIGHBORS


DISCREPANCIES.

TITLE COMMITMENT.

SURVEYS/PLATS. A FULL LAND TITLE REPORT

RIGHTS-OF-WAY PUBLIC OR PRIVATE.

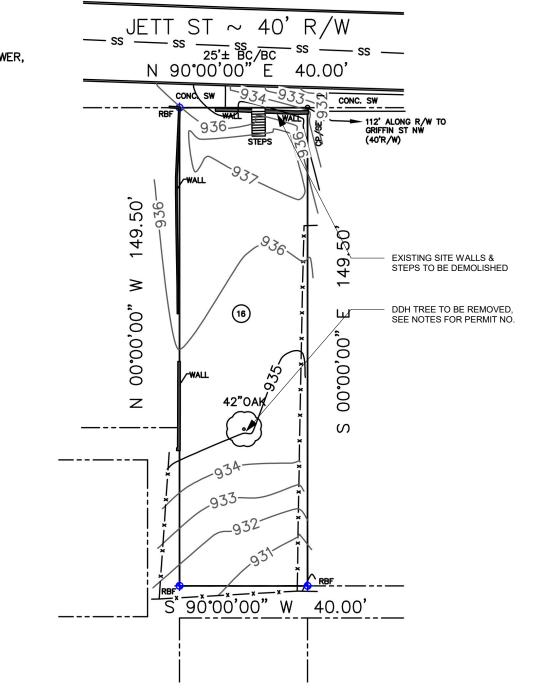

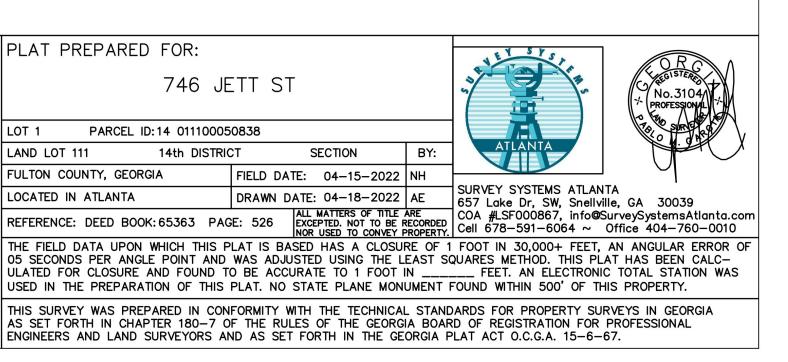

Official Survey 1" = 30'-0"

PROPERTY ADDRESS:

746 JETT ST NW,

ATLANTA, GA 30318

LAND AREA:


5980 SF

0.14 AC

IMPERVIOUS AREA:

EXIST= 71 SF= 1.2%

ZONING: SPI-3

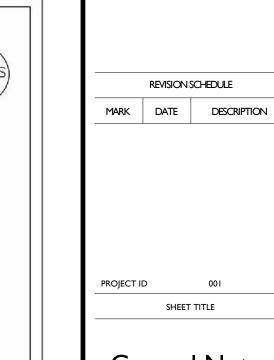

07/13/2022

General Notes and Official Survey

ISSUANCE SCHEDULE

PERMIT DOCS

SHEET NUMBER

DRIVEWAY WIDTH 7' DRIVEWAY 1" GUTTER LINE COMPACTED SUB-GRADE Slope 1/4" TO 1'-0" (2% min.

THIS DETAIL WAS TAKEN FROM THE CITY OF ATLANTA'S WEBSITE. IT MAY HAVE BEEN MODIFIED AND SHOULD BE REVIEWED THOROUGHLY.

STANDARD DETAILS


STANDARD DRIVEWAY


DETAIL

SCALE: N.T.S.

CAN EXCHANGE W./CONC. HEADER CURB OR GRANITE CURB.

City of Atlanta

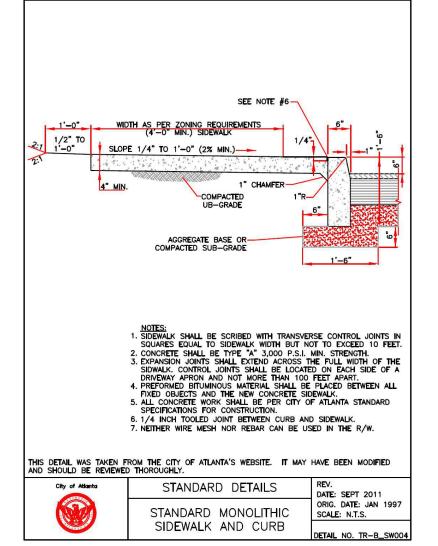

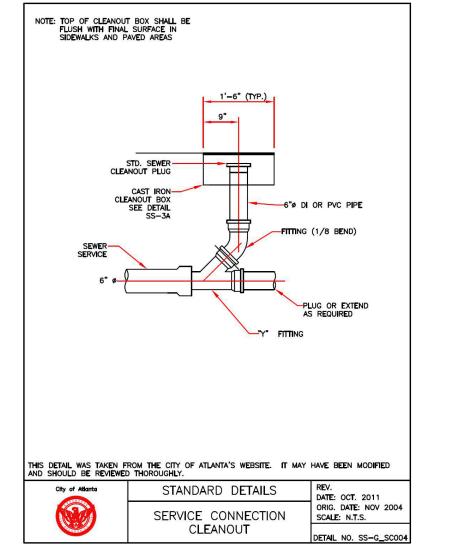


JETT STREET



Proposed Site Plan - Roof 1/8" = 1'-0"

Proposed Site Plan - Ground Floor 1/8" = 1'-0"

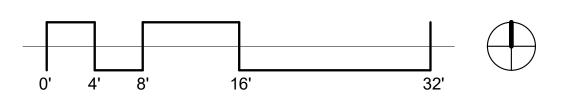

SAP APPLICATION NUMBER: SAP-22-123

ZONING SPI-3 SA1

LOT SIZE (IN SQFT)

NET LOT AREA (NLA) = (149.5)(40) 5980

SQFT

FAR = (COMBINED CONDITIONED SQFT/NLA)

BASE ALLOWED 2990 BASE PROVIDED 2090 MAIN UNIT CONDITIONED - 1ST FLOOR
MAIN UNIT CONDITIONED - 2ND FLOOR 726 852 512 2090 ADU CONDITIONED SPACE TOTAL

LOT COVERAGE PROVIDED

= (AREA OF BUILDING FOOTPRINTS, PORCHES)/(NLA)

MAX PERMITTED LOT COVERAGE 4186 PROVIDED LOT COVERAGE 1680

BUILDING FOOT PRINT - MAIN UNIT BUILDING FOOT PRINT - ADU 512 368 PORCHES 1680 TOTAL

RESIDENTIAL FACADE FENESTRATION

(% OF EACH STREET-FRONTING FACADE CALCULATED SEPARATELY, PER DISTRICT REGULATIONS)

MIN. REQUIRED 0.17 JETT ST PROVIDED

1. (1) LARGE: SHUMARD OAK OR BLACKGUM 2. (3) SMALL: REDBUD OR MUSCLEWOOD

FLOWERING SHRUBS
3. (4) ANNABELLE HYDRANGEA, FOTHERGILLA, OR ITEA

EVERGREEN SHRUBS
4. (3) INKBERRY, OR DWARF YAUPON HOLLY

RAIN GARDEN/BIOSWALE 5. (NOT USED) TREE

SMALL: SWEETBAY MAGNOLIA OR MUSCLEWOODTREE

LARGE: BALD CYPRESS 6. (AS NEEDED) SHRUBS

ITEA, INKBERRY, AND/OR CLETHRA

7. (AS NEEDED) GRASSES


SWITCHGRASS, SWEETFLAG FERNS (SHADE ONLY), CINNAMON FERN, NEW YORK FERN, LADY FERN FORBS, SCARLET HIBISCUS, JOE-PYE WEED, BACKEYED SUSAN, BOLTONIA, AND/OR FOAMFLOWER (SHADE

STORMWATER MITIGTION BY A RAIN GARDEN

CONTRIBUTING AREA: 2307 SF DEPTH OF AMENDED SOIL: 18" AREA OF RAIN GARDEN: 388 SF

DIRECT ALL DOWNSPOUT TO RAIN GARDEN

ROUTINE GARDEN MAINTENANCE SHOULD INCLUDE WEEDING, DEADHEADING, REPLACING DEAD PLANTS, AND REPLENISHING MULCH WHEN DEPLETED. CATCHING AREAS OF EROSION IS ALSO IMPORTANT AS IS CORRECTING STANDING WATER PROBLEMS. IF STANDING WATER PERSISTS IT MAY BE NECESSARY TO PLACE A PERFORATED UNDERDRAIN IN THE GARDEN DAYLIGHTING DOWNSTREAM.

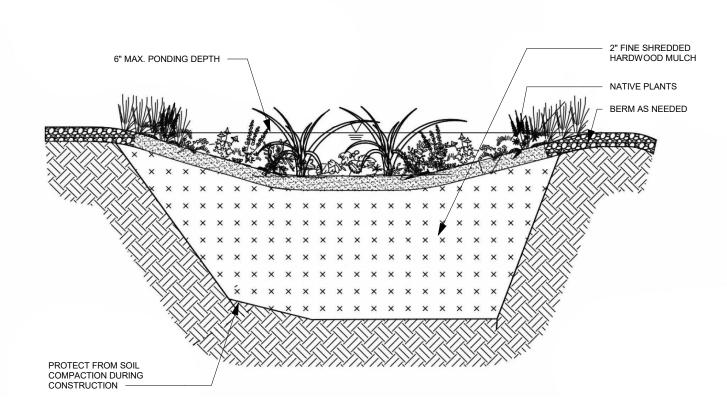

RAIN GARDEN - TYPICAL CROSS-SECTION

FLOURISHING COMMUNITIES COLLABORATIVE


ISSUANCE SCHEDULE 07/13/2022 PERMIT DOCS

REVISION SCHEDULE MARK DATE DESCRIPTION

I 09/27/2022 REVISED PERMIT

PROJECT ID

Proposed Site

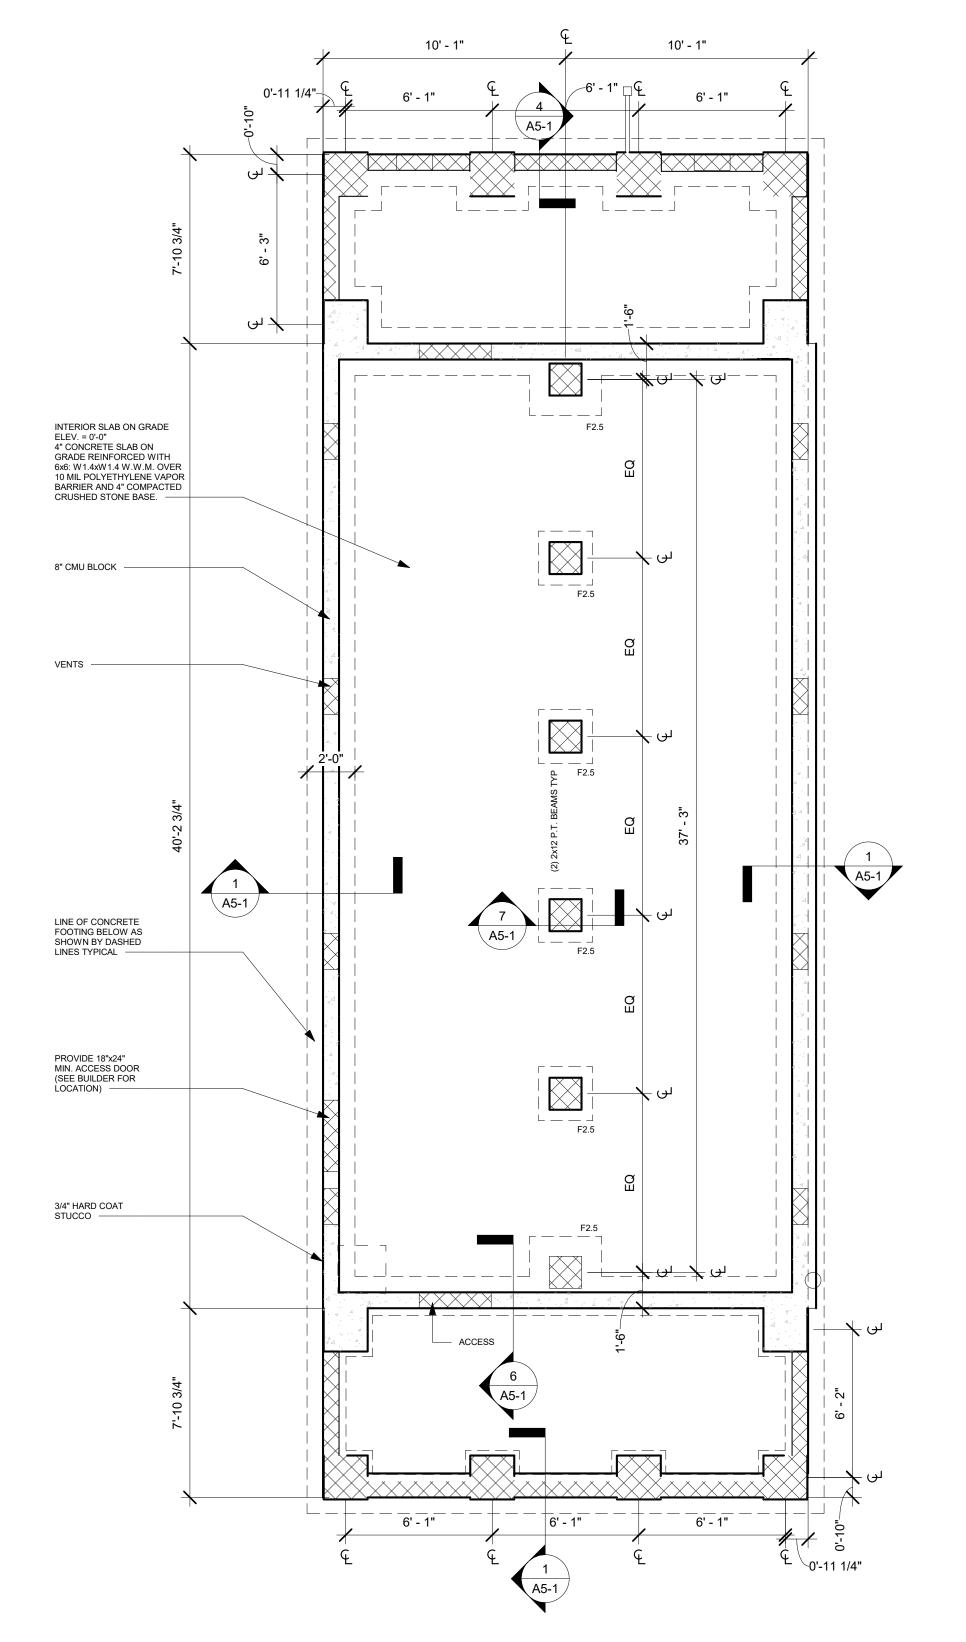

MARK	FOOTING SIZE	REINFORCEMENT
F2.5	2'-6" x 2'-6" x 12"	(3) #5 x 2'-0" LONG EACH WAY

ALL POSTS ARE (3) 2x TYP, UNO
 S.J. - SLAB JOINT (SAWCUT CONTRACTION JOINT OR FORMED CONSTRUCTION JOINT @CONTRACTOR'S OPTION)

Proposed Slab Plan - ADU
1/4" = 1'-0"

10'-5 1/4"

4" CONC. SLAB

16'-0 3/4"

4" CONC. SLAB —

- #4x4'-0" LONG INSTALLED IN SLAB @WALL CORNERS TO LIMIT CRACKING IN SLAB. (CENTER IN SLAB)

LINE OF GRADE BEAM WITHIN MONOLITHIC SLAB

LINE OF BEARING PLATE

- INTERIOR SLAB ON GRADE ELEV. = 0'-0"
4" CONCRETE SLAB ON GRADE REINFORCED WITH
6x6: W1.4xW1.4 W.W.M. OVER 10 MIL
POLYETHYLENE VAPOR BARRIER AND 4"
COMPACTED CRUSHED STONE BASE.

- EXTERIOR SLAB ON GRADE ELEV. = 0'-0"
4" CONCRETE SLAB ON GRADE REINFORCED WITH
6x6: W1.4xW1.4 W.W.M. OVER 10 MIL
POLYETHYLENE VAPOR BARRIER AND 4"
COMPACTED CRUSHED STONE BASE.


Proposed Foundation Plan - Main Unit
1/4" = 1'-0"


ISSUANCE SCHEDULE 07/13/2022 PERMIT DOCS

REVISION SCHEDULE MARK DATE DESCRIPTION 2 03/05/2023 REVISED STRUCTURAL DETAILS

PROJECT ID

Proposed Foundation **Plans**

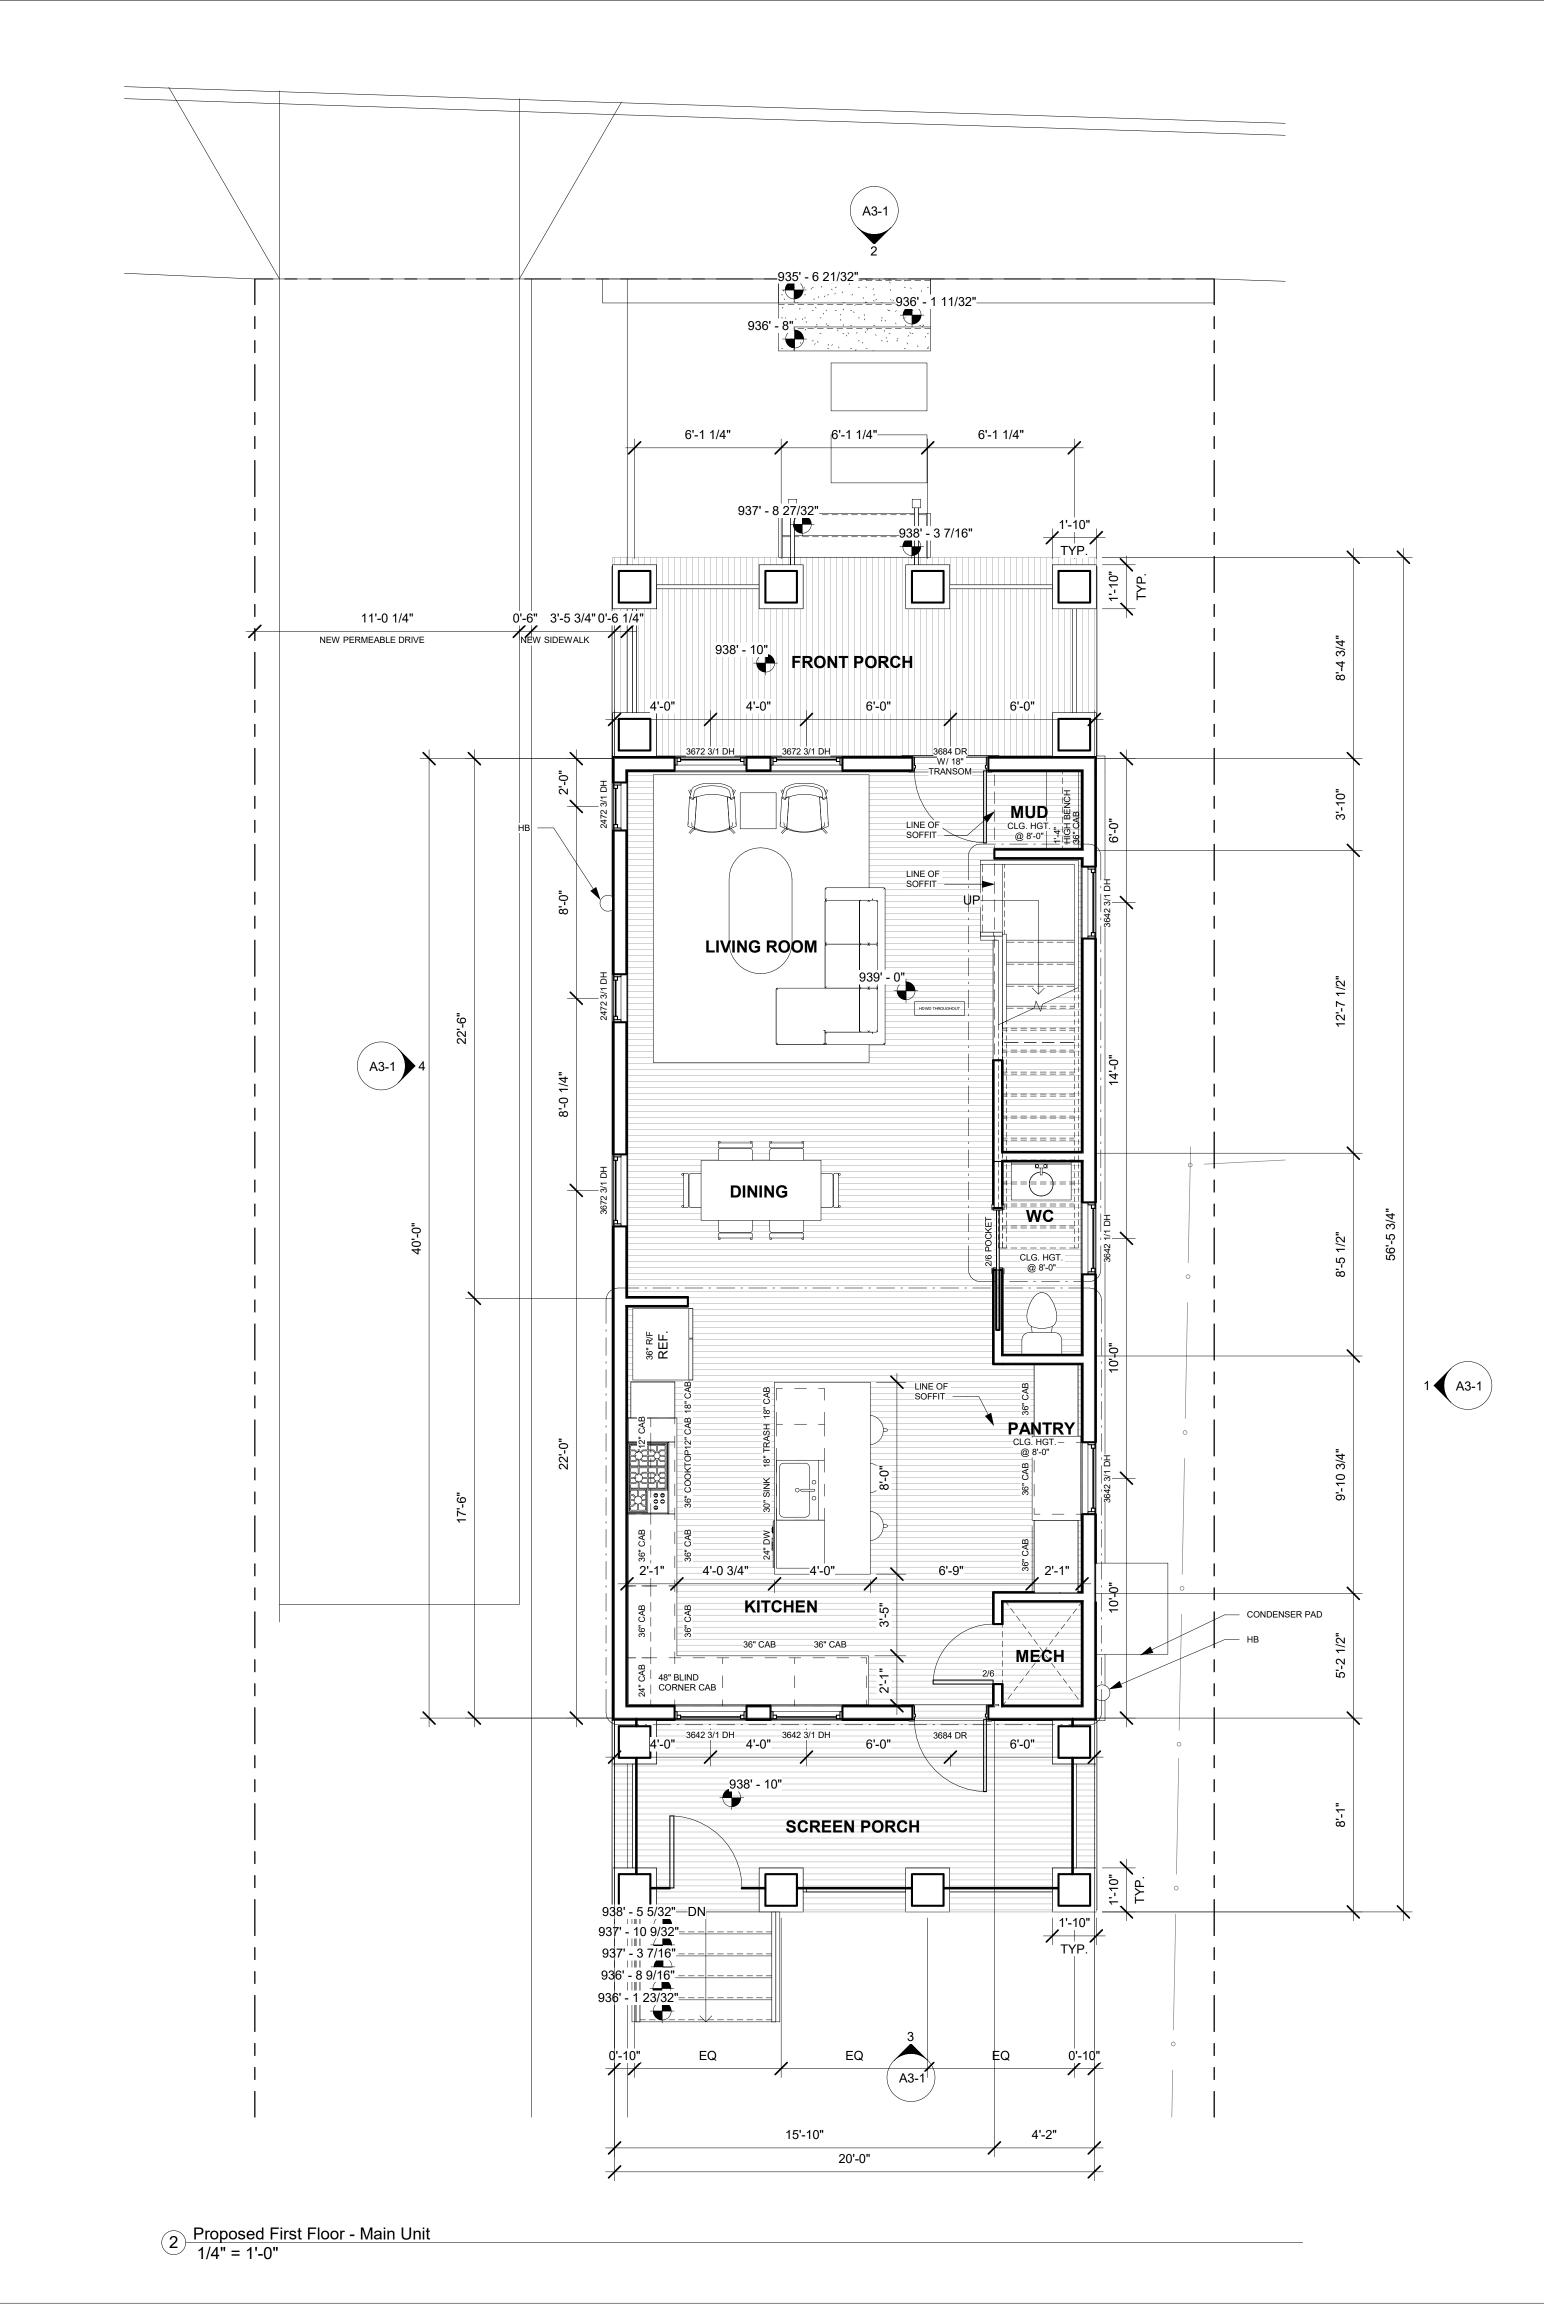

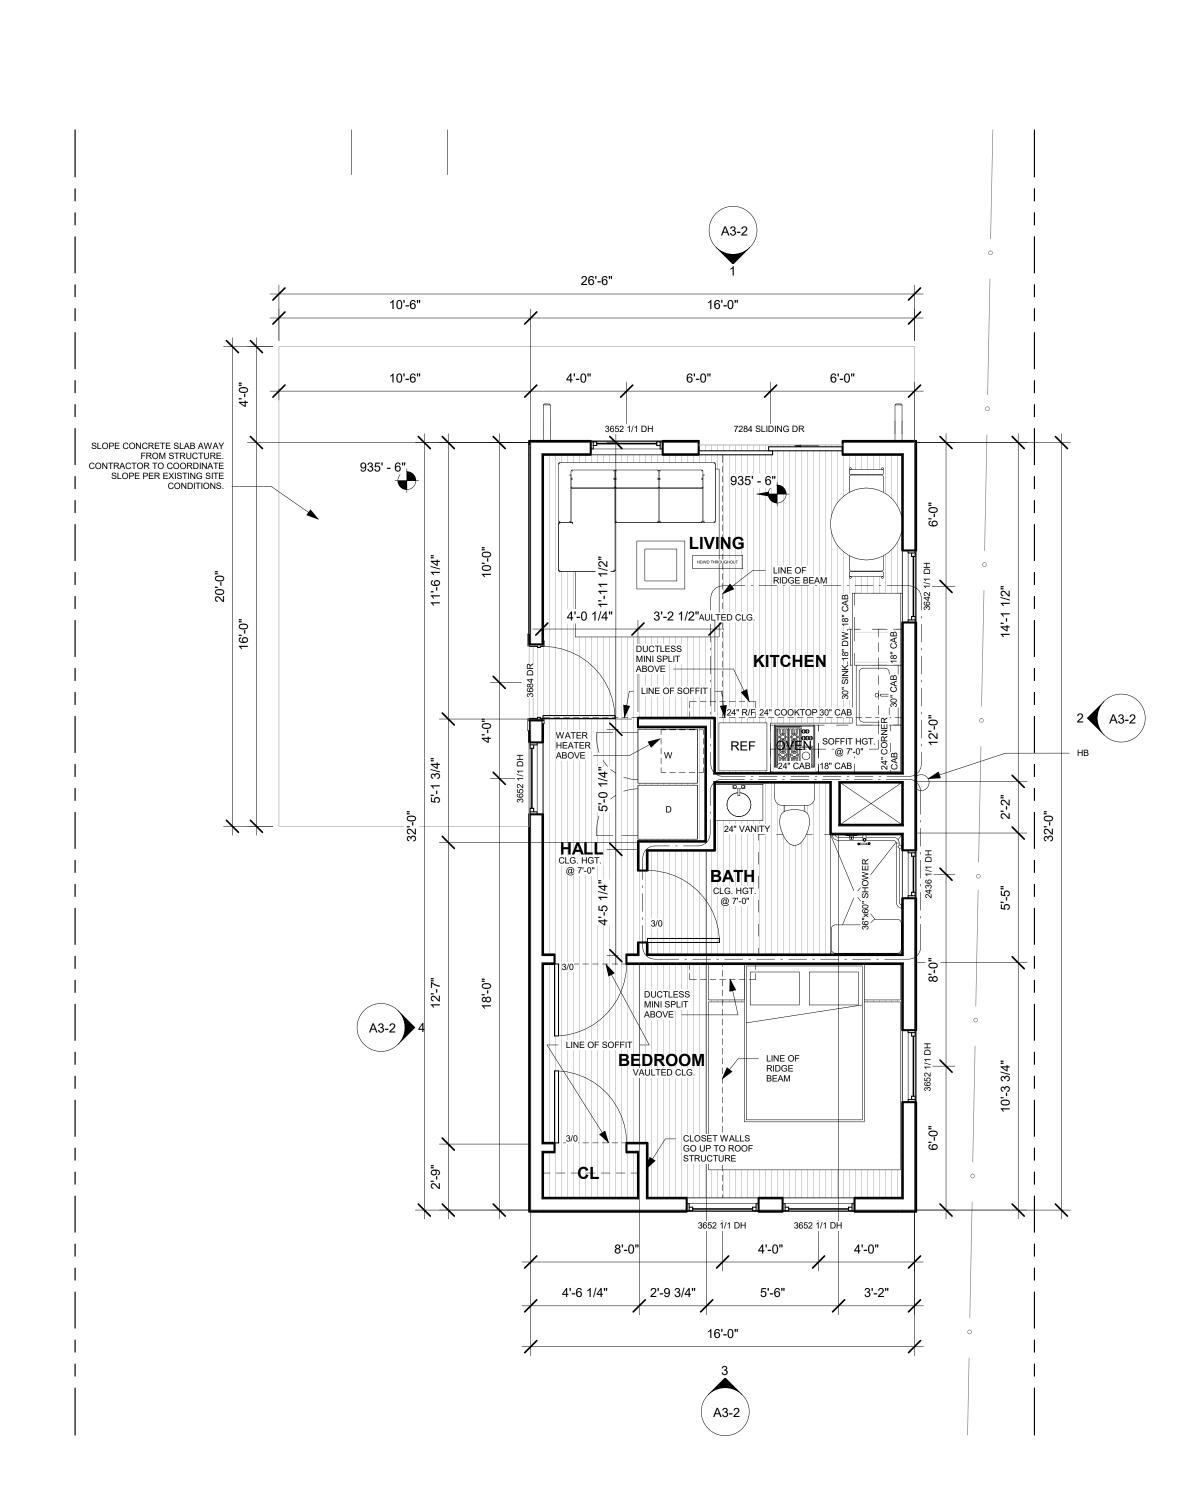

1 Proposed First Floor - ADU 1/4" = 1'-0"

\$ A2−1

PROJECT ID

JETT

ISSUANCE SCHEDULE

REVISION SCHEDULE

MARK DATE DESCRIPTION

Proposed First

Floor Plans

07/13/2022 PERMIT DOCS

FLOURISHING COMMUNITIES COLLABORATIVE

8'-0" 6'-0" ROOF BELOW 8'-1 3/4" 11'-10 1/4" | 3652 3/1 DH DESK SPACE BEDROOM #2 CLG. HGT. -- -@ 8'-0"-- **CL** --HALL
VAULTED CLG.
@ 6:12
HEWED THROUGHOUT BEDROOM #1

CLG. HGT.
@ 8'-0" THE DN HALL BOUNDING
 WALLS GO UP TO
 ROOF STRUCTURE --30"x72" ALCOVE TUB ☐ MAIN CL CLG. HGT. @ 8'-0" BEDROOM & BATH BOUNDING WALLS GO UP TO ROOF STRUCTURE LINE OF RIDGE BEAM MAIN BEDROOM MAIN BATH 3652 3/1 DH 2436 1/1 DH 4'-0" 4'-0" 3'-9" 6'-2 1/4" 5'-8" 4'-5" Proposed Second Floor - Main Unit
1/4" = 1'-0"

FLOURISHING COMMUNITIES COLLABORATIVE

ITEJEL SIREL
746 JETT STREET
ATLANTA, GA 30318

ISSUANCE SCHEDULE

07/13/2022 PERMIT DOCS

REVISION SCHEDULE

MARK DATE DESCRIPTION

PROJECT ID 001
SHEET TITLE

Proposed

Proposed Second Floor Plan

SHEET NUMBER

A2-2

SIDENCES

FLOURISHING COMMUNITIES COLLABORATIVE

THE JETT STREET
ATLANTA, GA 30318

ISSUANCE SCHEDULE

07/13/2022 PERMIT DOCS

REVISION SCHEDULE


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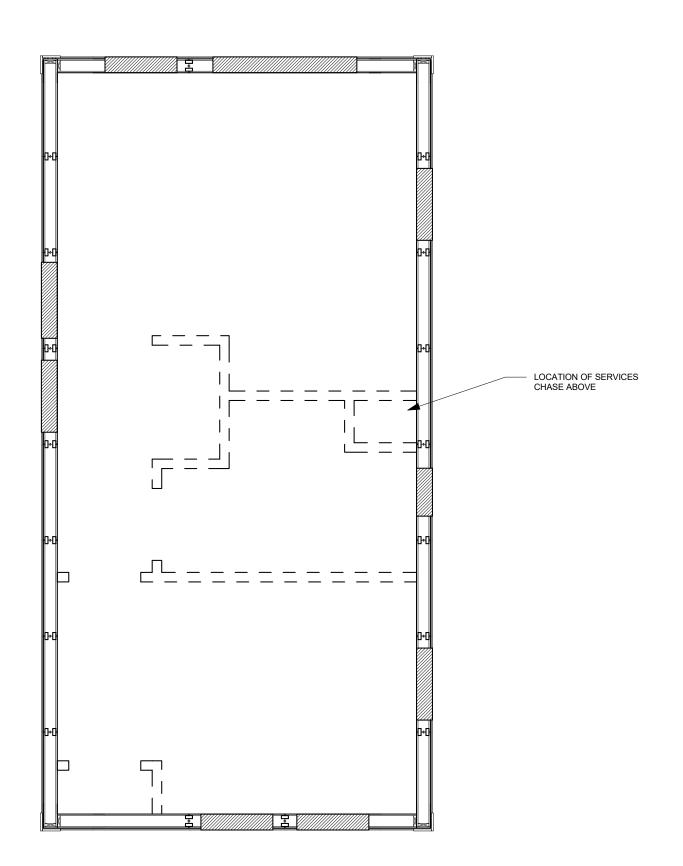
2 03/05/2023 REVISED STRUCTURAL DETAILS


PROJECT ID 001

First Floor Framing Plans

SHEET NUMBER



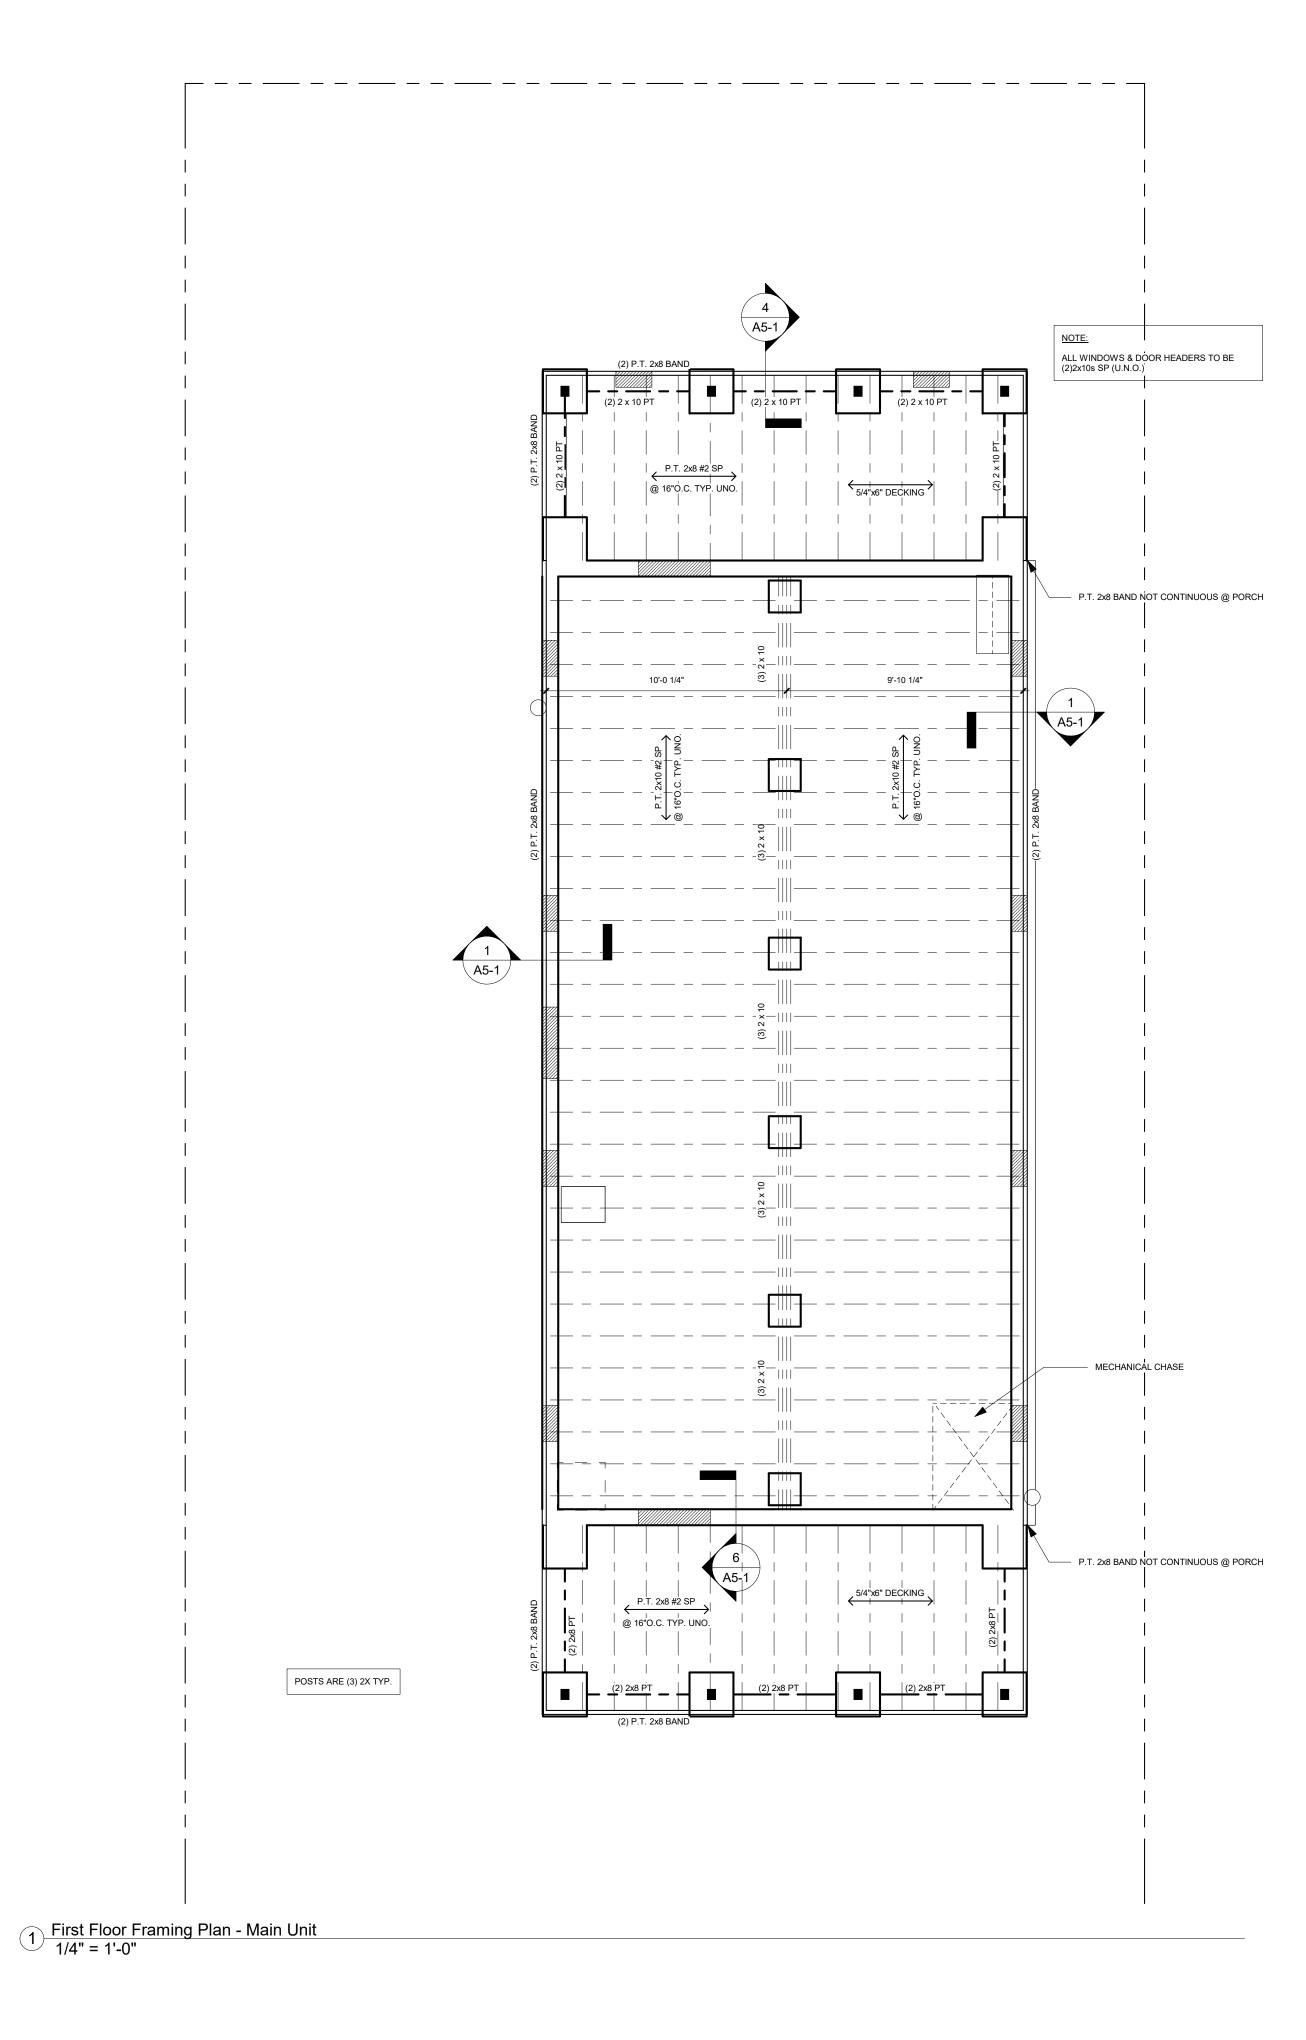

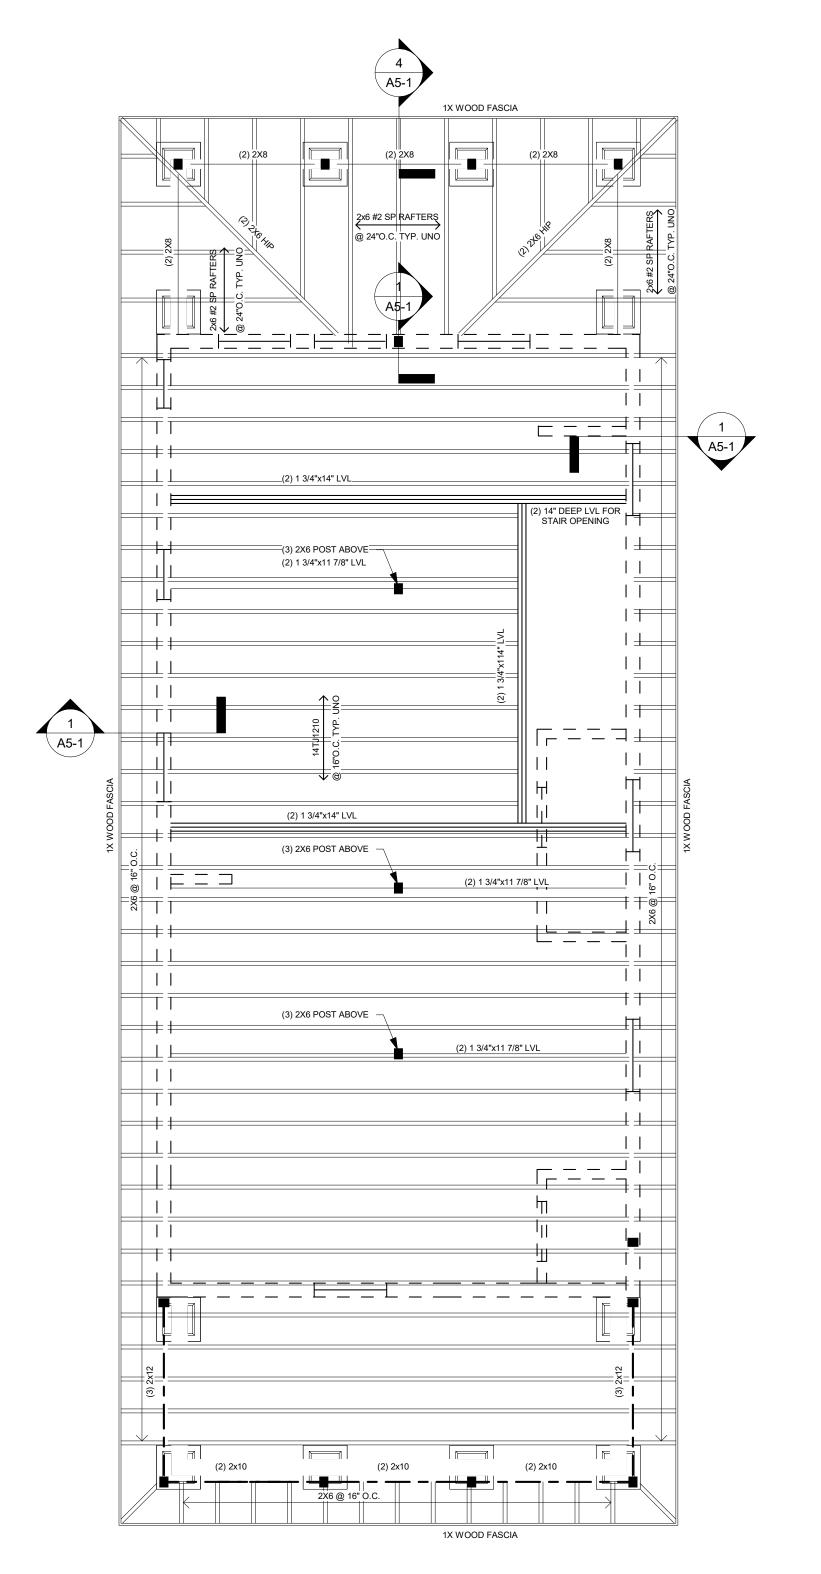

ALL WINDOWS & DOOR HEADERS TO BE (2)2X10 SYP (U.N.O.) ALL POSTS (3)2x, TYP, UNO

07/13/2022 PERMIT DOCS

REVISION SCHEDULE

MARK DATE DESCRIPTION

ISSUANCE SCHEDULE

RESIDENCES

MARK DATE DESCRIPTION

2 03/05/2023 REVISED STRUCTURAL DETAILS

PROJECT ID 001
SHEET TITLE


Second Floor Framing Plan


SHEET NUMBER

A2-4

Second Floor Framing Plan - Main Unit
1/4" = 1'-0"

ALL WINDOWS & DOOR HEADERS TO BE (2) 2x10 SP (U.N.O.) ALL POSTS (3)2x, TYP, UNO.

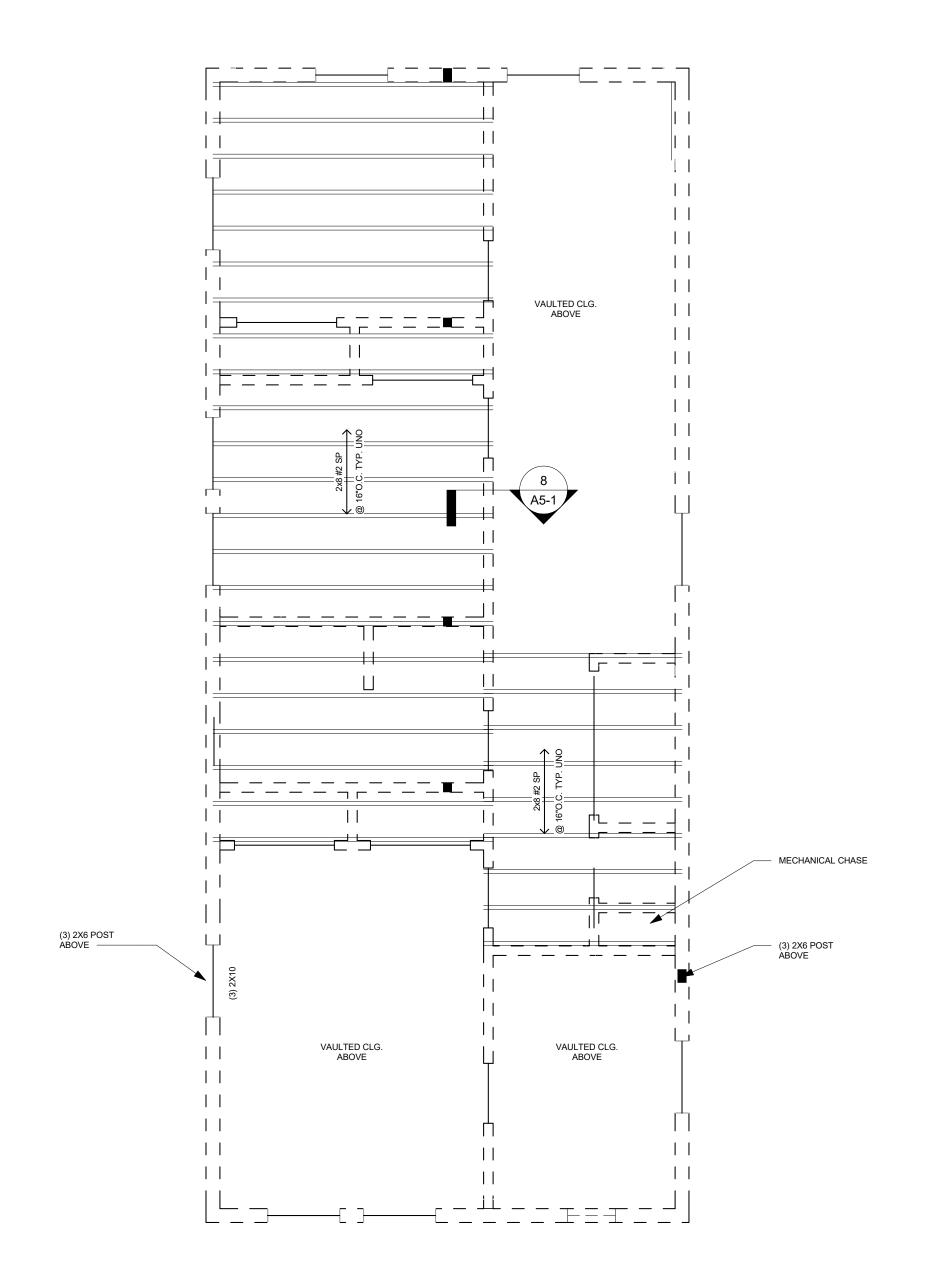

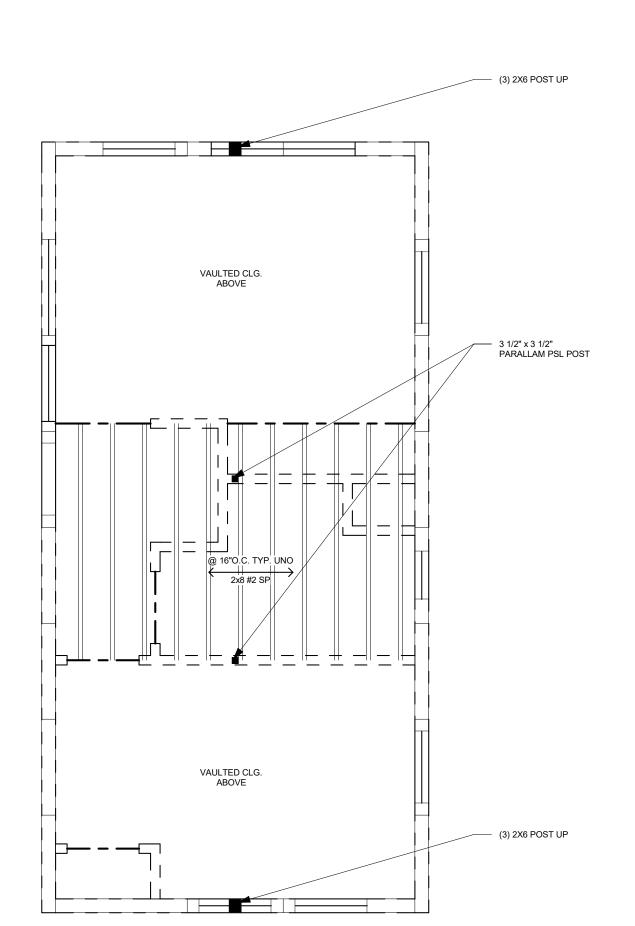

Second Floor Ceiling Framing Plan - Main

Unit

1/4" = 1'-0"

2 First Floor Ceiling Framing Plan - ADU 1/4" = 1'-0"

SHEET NUMBER

A 2 - 5

PROJECT ID

RESIDENCE

ISSUANCE SCHEDULE

REVISION SCHEDULE

MARK DATE DESCRIPTION

2 03/05/2023 REVISED STRUCTURAL DETAILS

Ceiling Framing

07/13/2022 PERMIT DOCS

ALL WINDOWS & DOOR HEADERS TO BE (2) 2x10 SP (U.N.O.)

ISSUANCE SCHEDULE

746 JETT STREET

ATLANTA, GA 30318

REVISION SCHEDULE

MARK DATE DESCRIPTION

MARK DATE DESCRIPTION


2 03/05/2023 REVISED STRUCTURAL DETAILS

PROJECT ID 0
SHEET TITLE

Roof Framing Plans


SHEET NUMBER


A 2 - 6

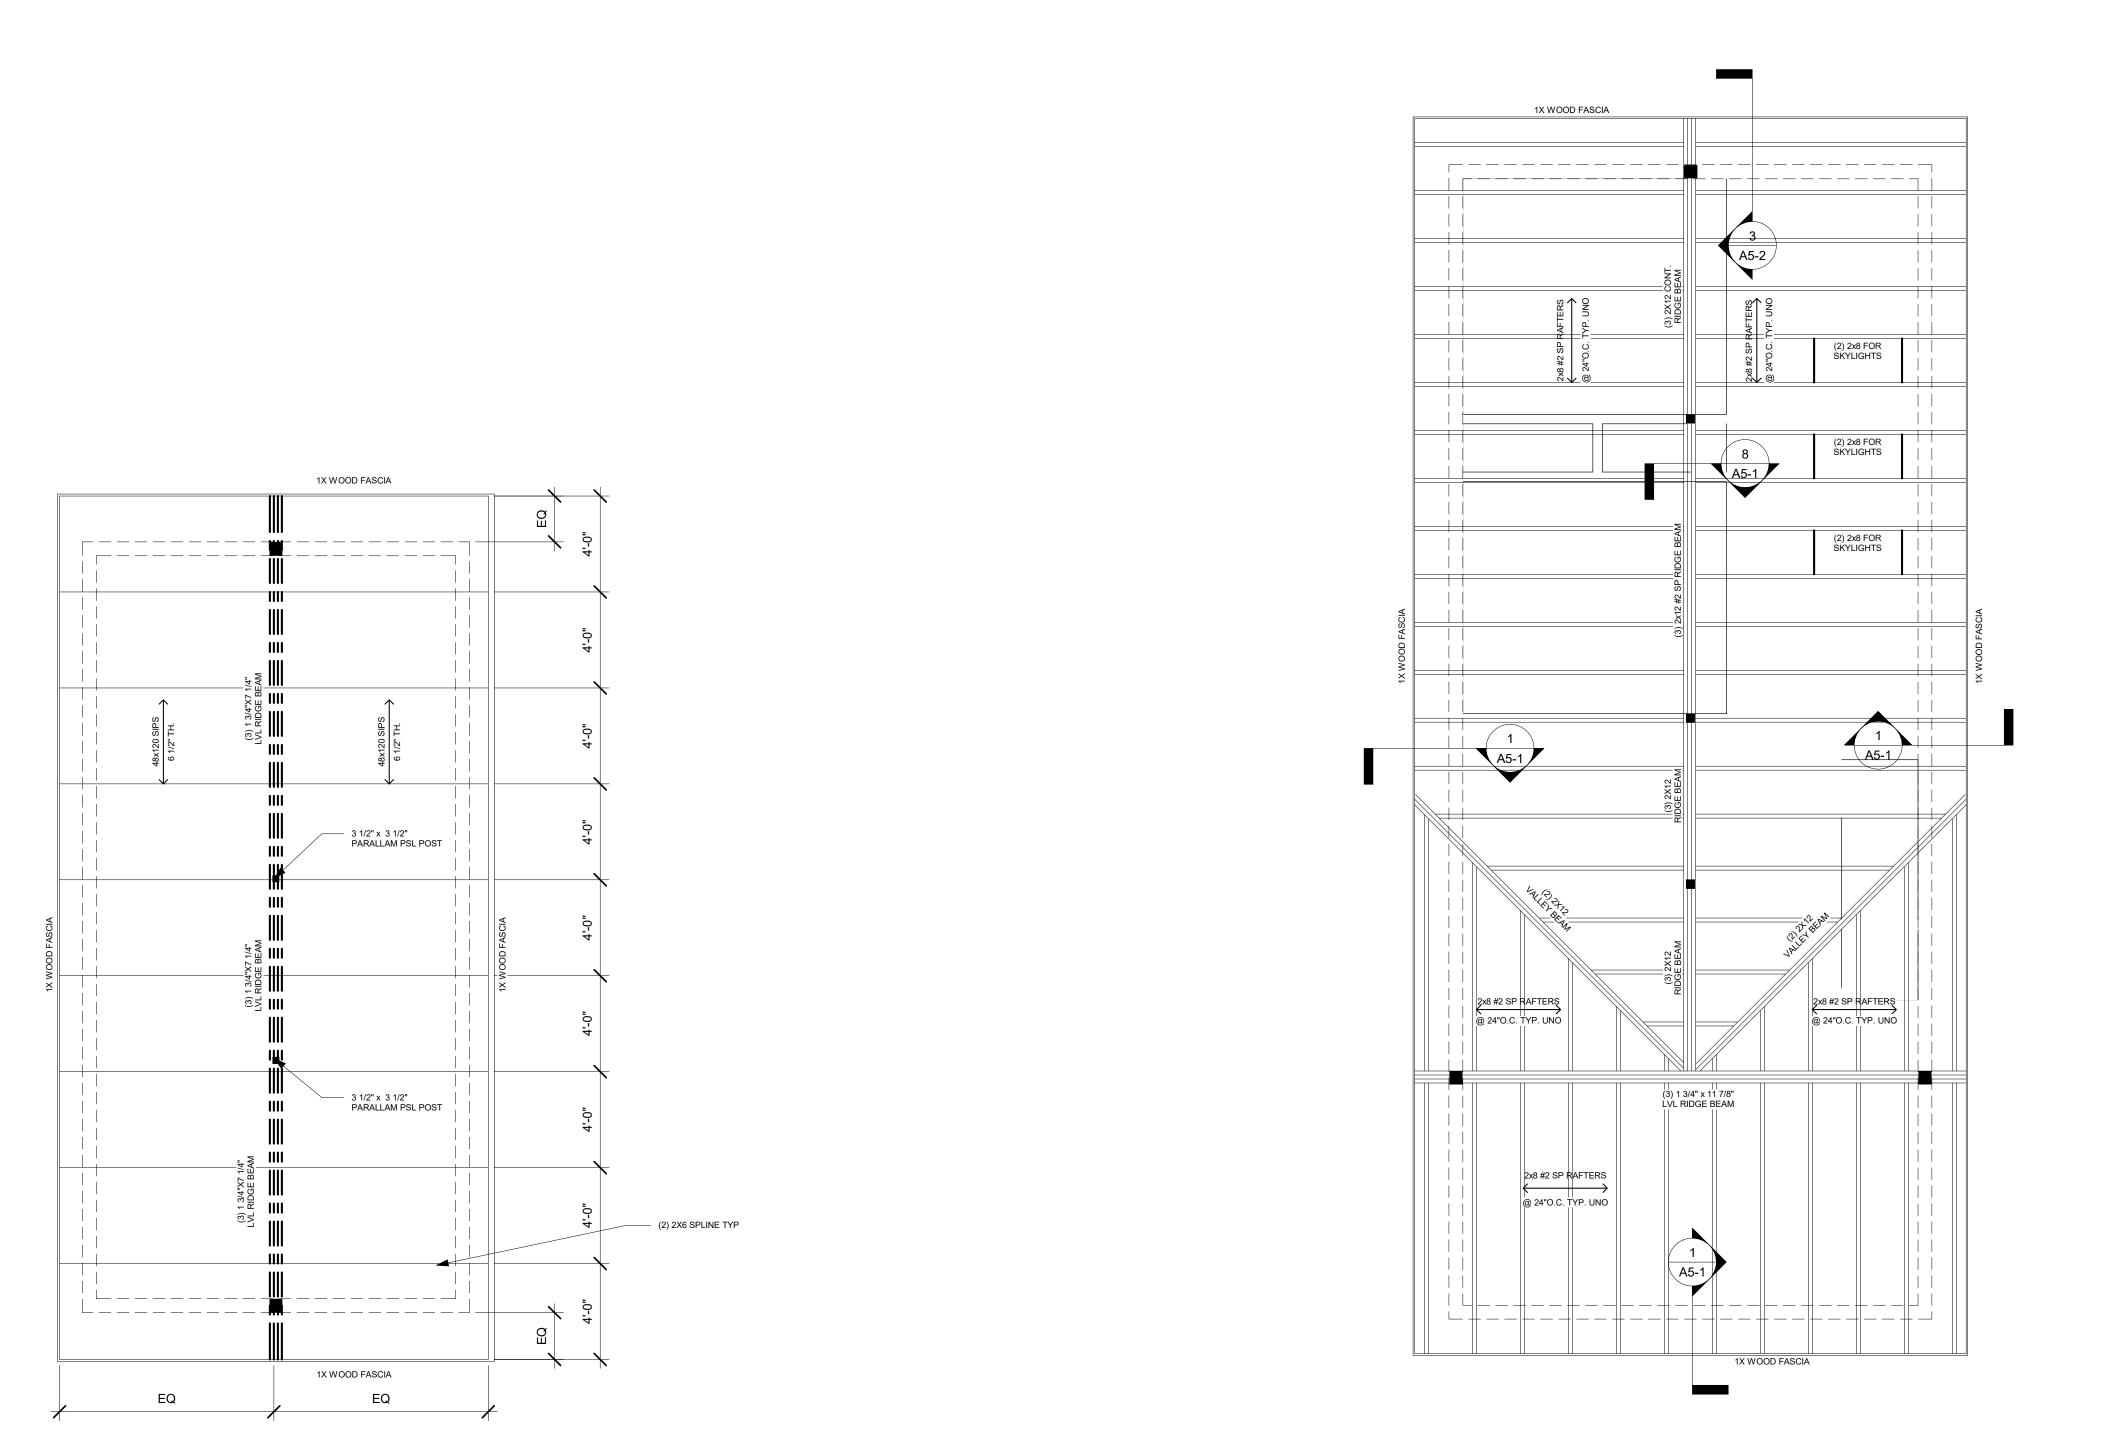

Roof Framing Plan - Main Unit
1/4" = 1'-0"

SIDENCE

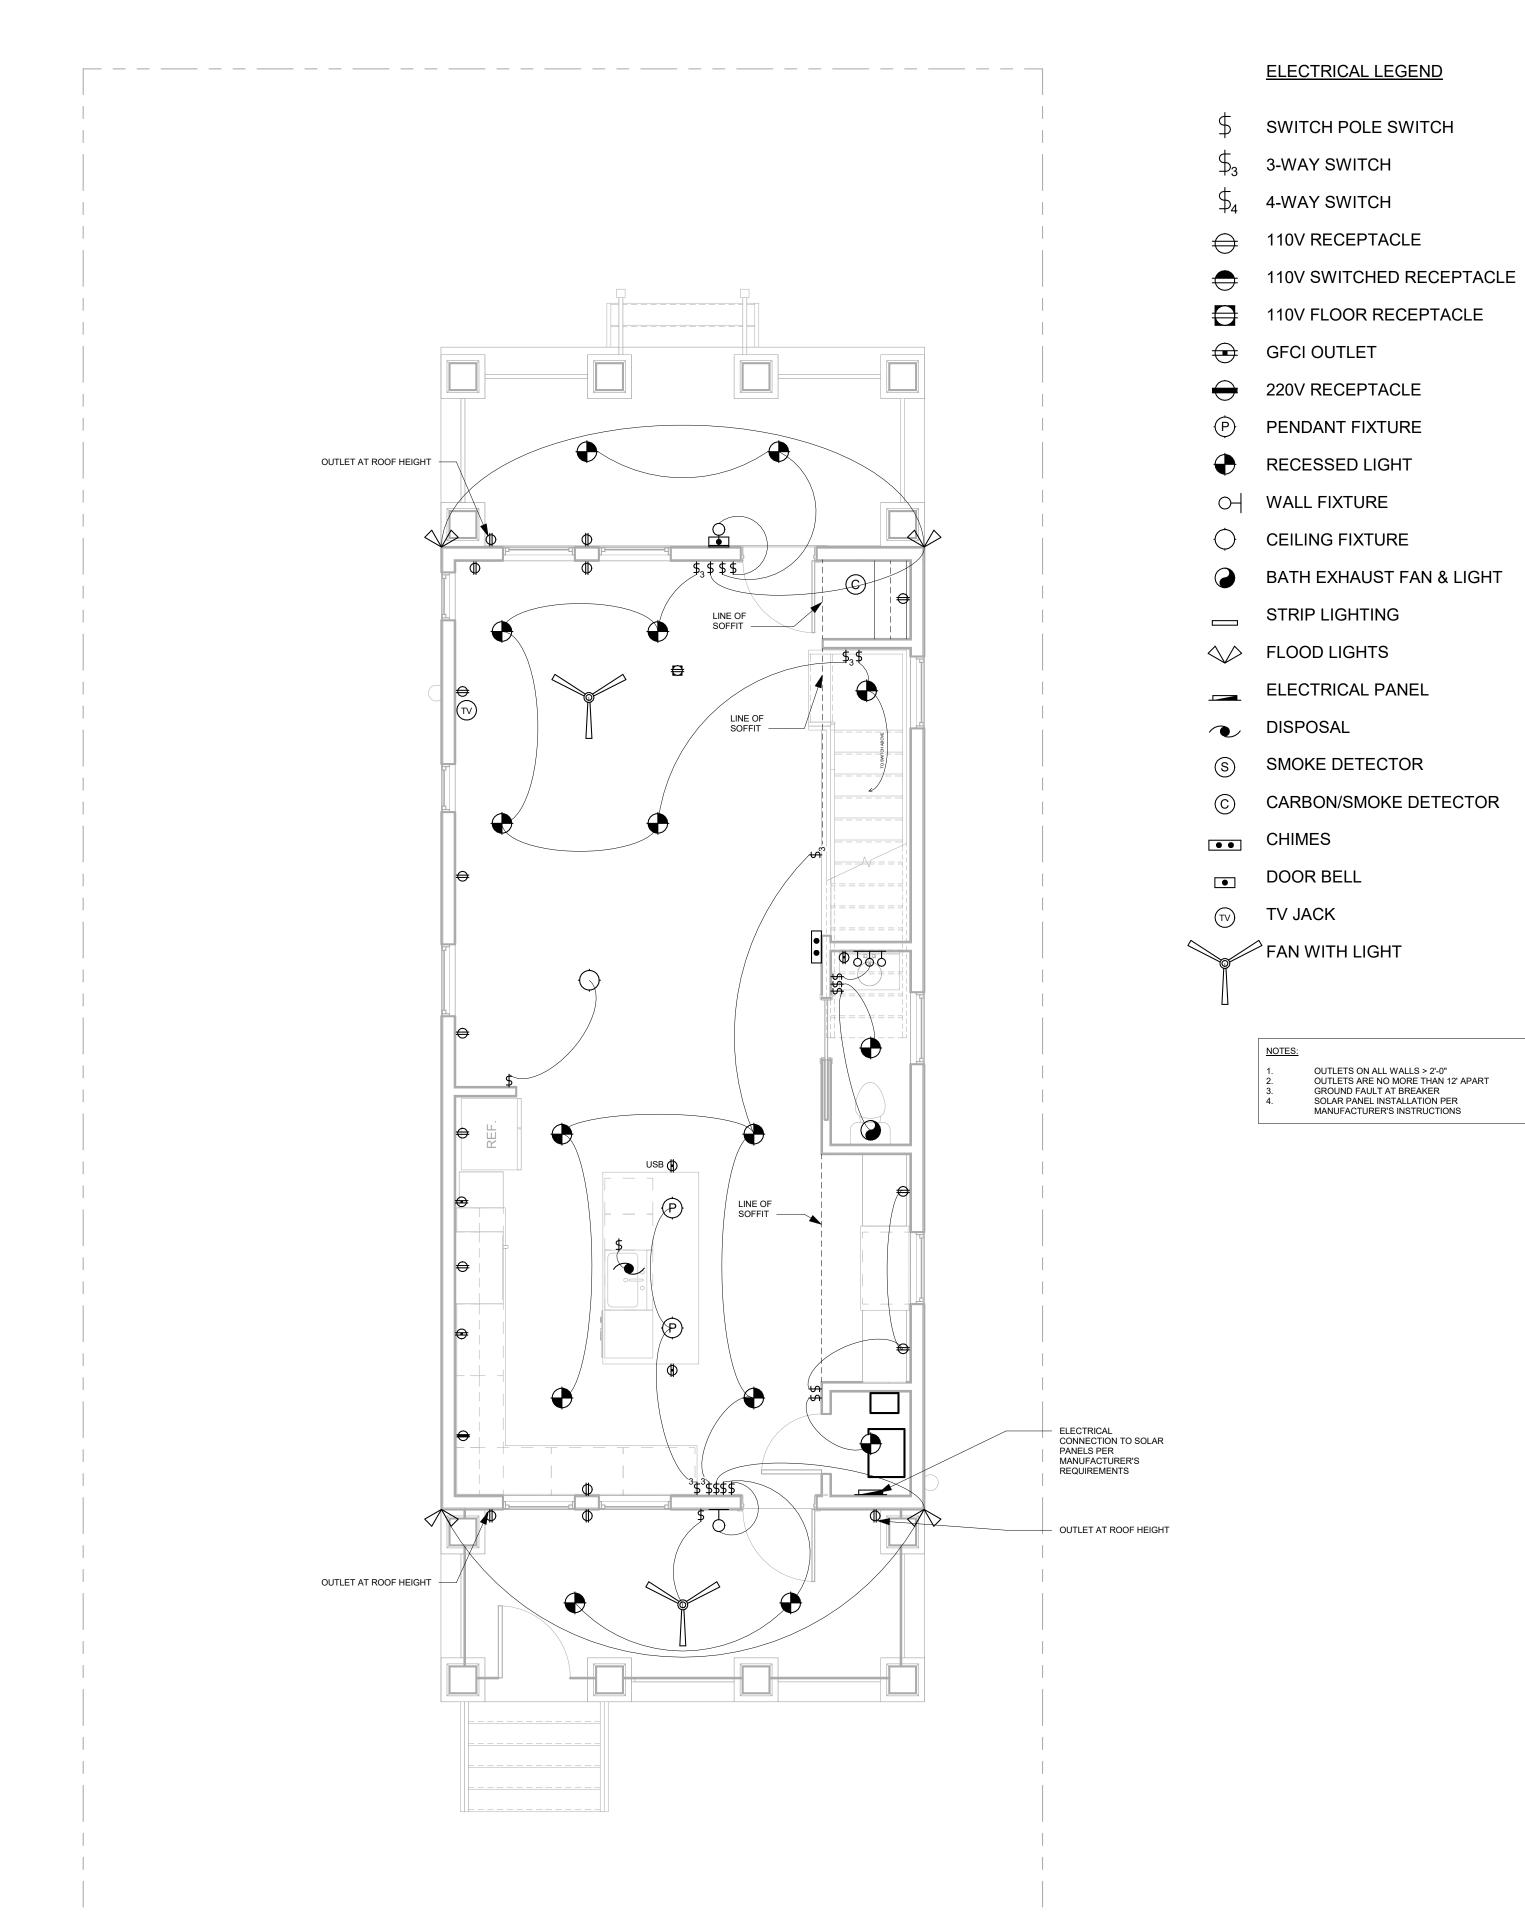

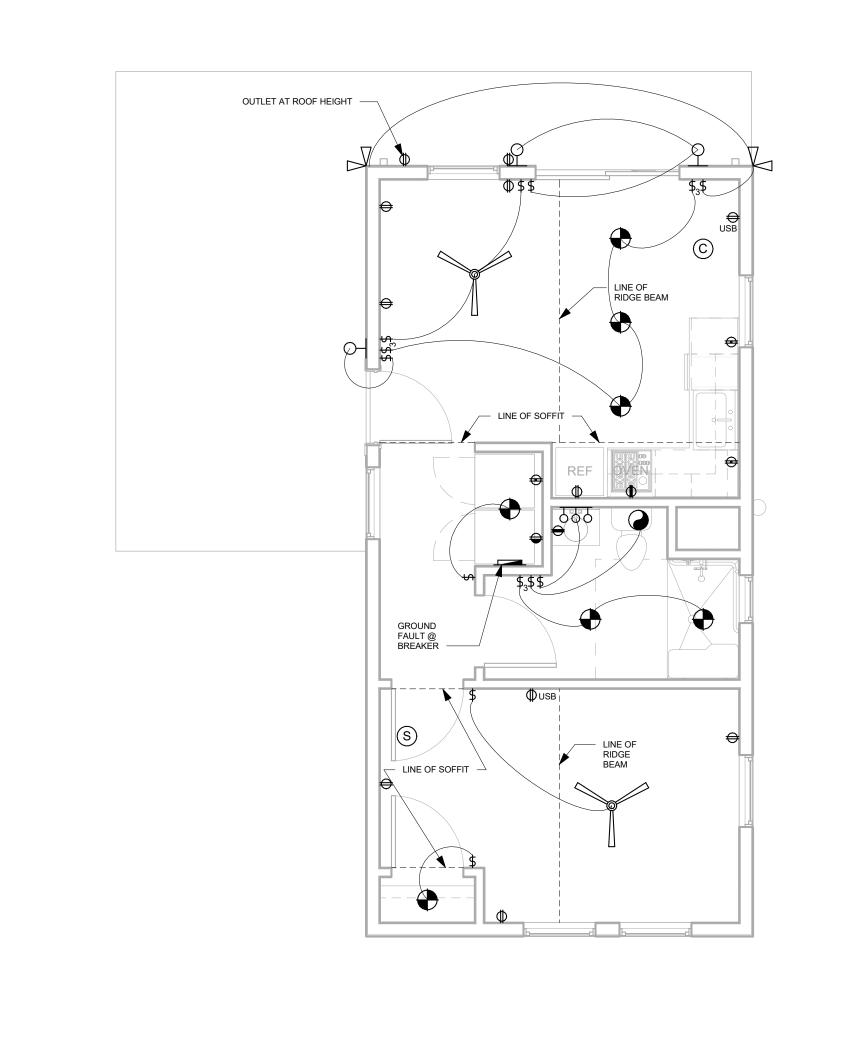

2 First Floor Electrical Plan - ADU 1/4" = 1'-0"

First Floor Electrical Plan - Main Unit
1/4" = 1'-0"

VED FOR PER

SHEET NUMBER

First Floor

Electrical Plans

PROJECT ID

ISSUANCE SCHEDULE

REVISION SCHEDULE

MARK DATE DESCRIPTION

07/13/2022 PERMIT DOCS

A2-7

OUTLETS ON ALL WALLS > 2'-0"
OUTLETS ARE NO MORE THAN 12' APART
GROUND FAULT AT BREAKER
SOLAR PANEL INSTALLATION PER
MANUFACTURER'S INSTRUCTIONS

ELECTRICAL LEGEND

SWITCH POLE SWITCH

110V SWITCHED RECEPTACLE

110V FLOOR RECEPTACLE

220V RECEPTACLE

PENDANT FIXTURE

BATH EXHAUST FAN & LIGHT

\$3 3-WAY SWITCH

\$4 4-WAY SWITCH

GFCI OUTLET

RECESSED LIGHT

CEILING FIXTURE

어 WALL FIXTURE

STRIP LIGHTING

DISPOSAL

•• CHIMES

TV JACK

DOOR BELL

ELECTRICAL PANEL

S SMOKE DETECTOR

FAN WITH LIGHT

© CARBON/SMOKE DETECTOR

LINE OF RIDGE BEAM

PROJECT ID

ISSUANCE SCHEDULE

REVISION SCHEDULE

MARK DATE DESCRIPTION

07/13/2022 PERMIT DOCS

Second Floor Electrical Plans


ISSUANCE SCHEDULE 07/13/2022 PERMIT DOCS

REVISION SCHEDULE MARK DATE DESCRIPTION I 09/27/2022 REVISED PERMIT DOCS.V2


PROJECT ID


Proposed Exterior

Elevations

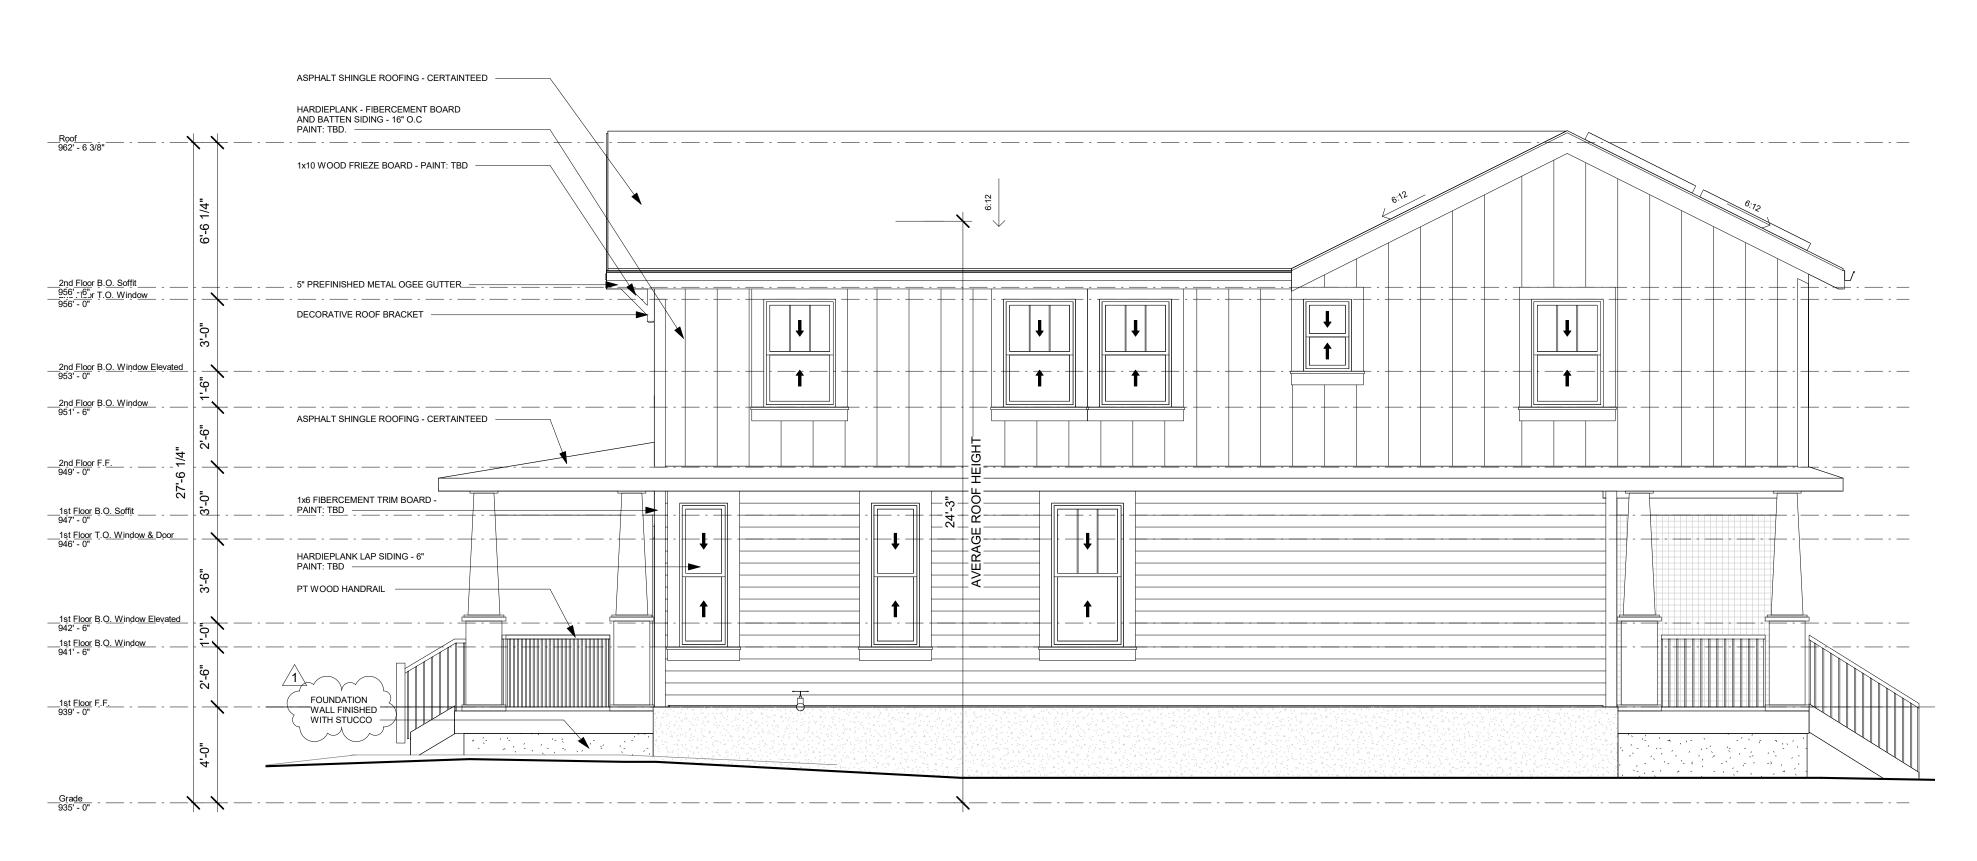


Proposed Driveway Elevation - Main Unit 1/4" = 1'-0"

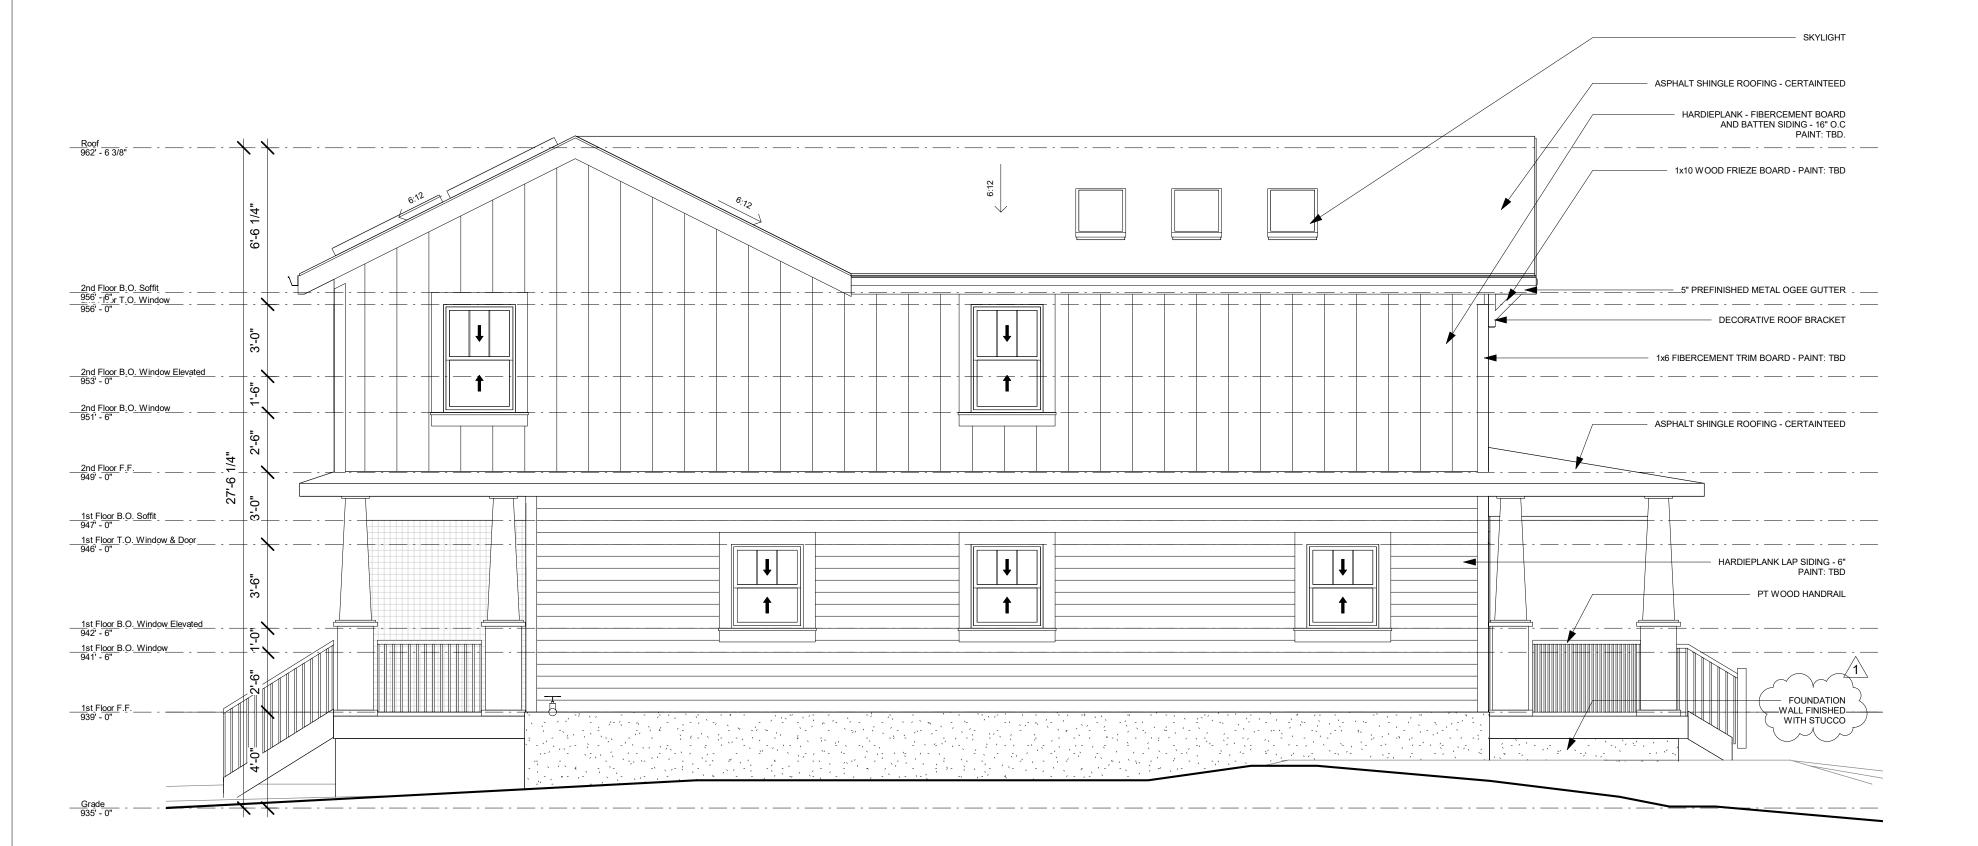

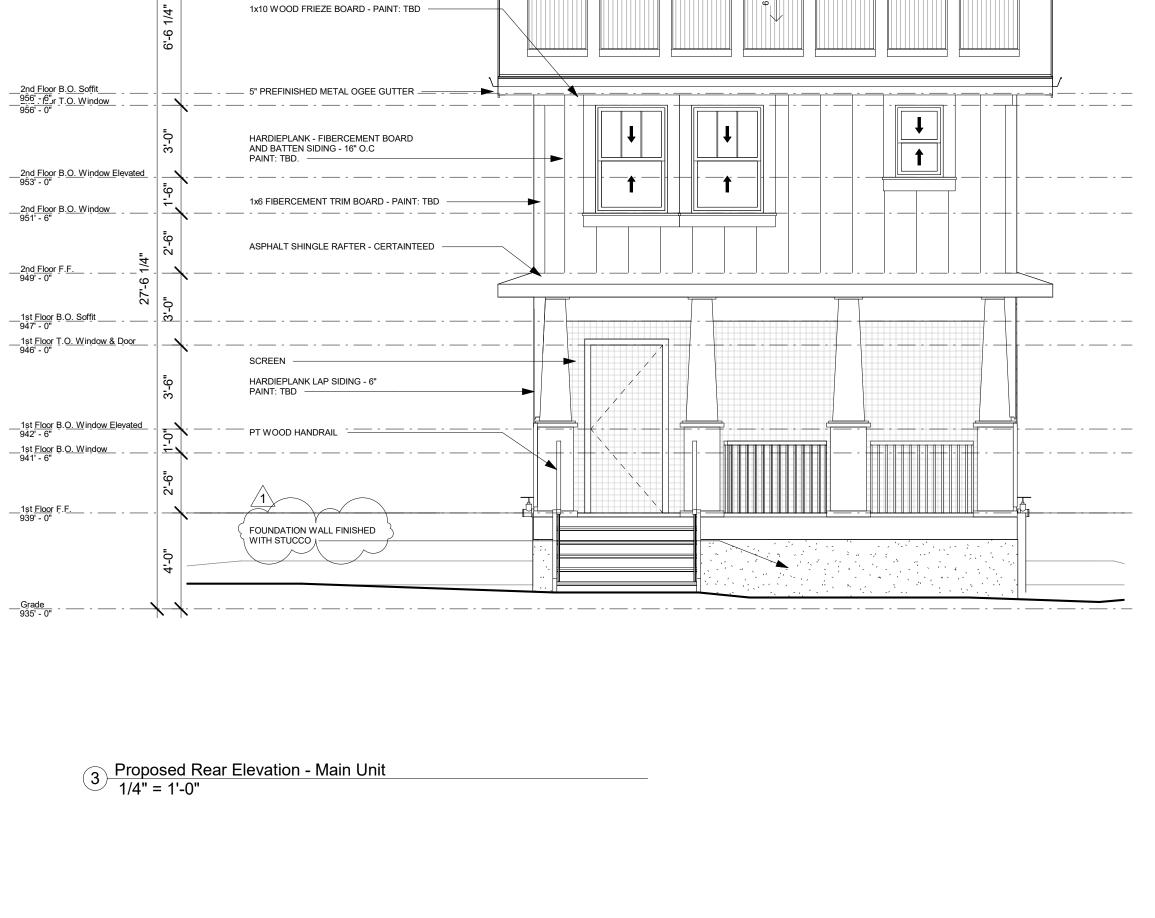

ASPHALT SHINGLE ROOFING - CERTAINTEED -

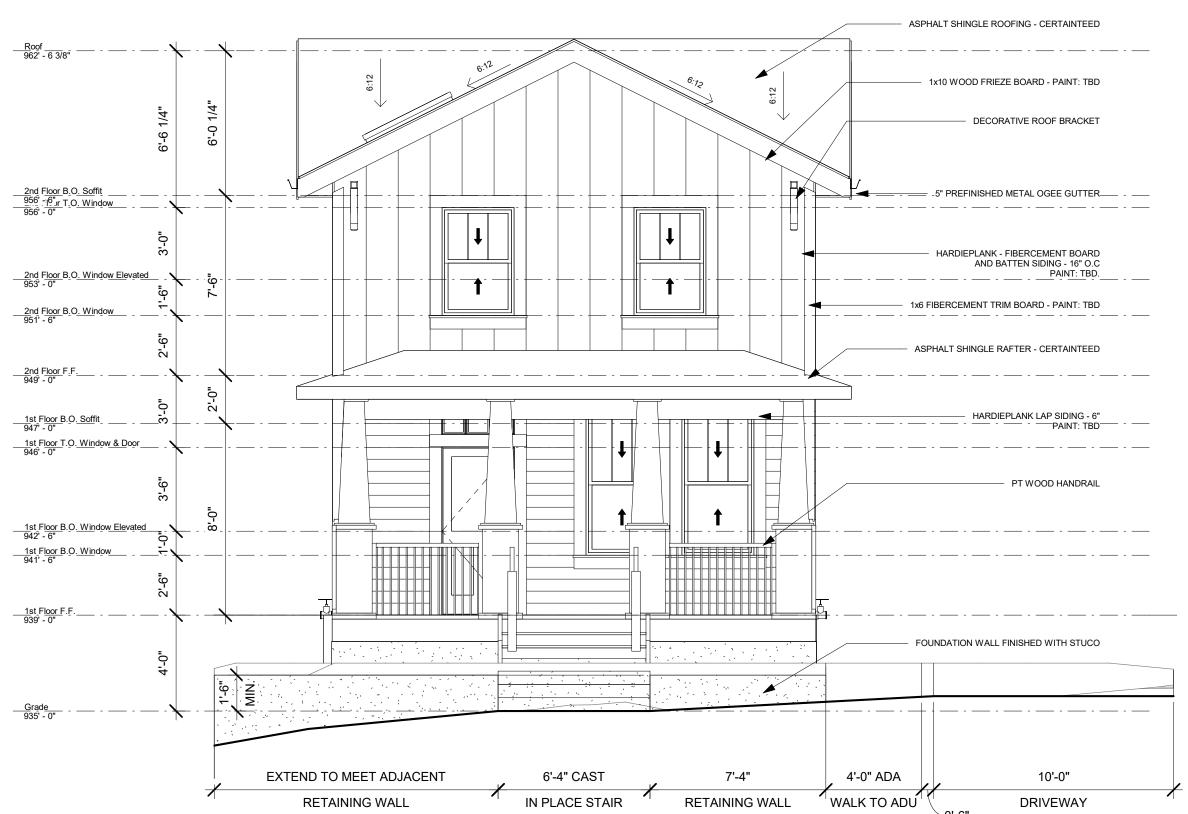

Proposed Sideyard Elevation - Main Unit 1/4" = 1'-0"

MARK DATE DESCRIPTION


PROJECT ID

Proposed Exterior **Elevations**


SHEET NUMBER


ASPHALT SHINGLE ROOFING - CERTAINTEED ----HARDIEPLANK - FIBERCEMENT BOARD AND BATTEN SIDING - 16" O.C PAINT: TBD. 1x10 WOOD FRIEZE BOARD - PAINT: TBD 5" PREFINISHED METAL OGEE GUTTER — ADU B.O. Soffit & T.O. Window & Door 942' - 6" DECORATIVE ROOF BRACKET -1x6 FIBERCEMENT TRIM BOARD - PAINT: TBD ___ADU B.Q. Window Elevated 939' - 0"

Proposed Driveway Elevation - ADU 1/4" = 1'-0"

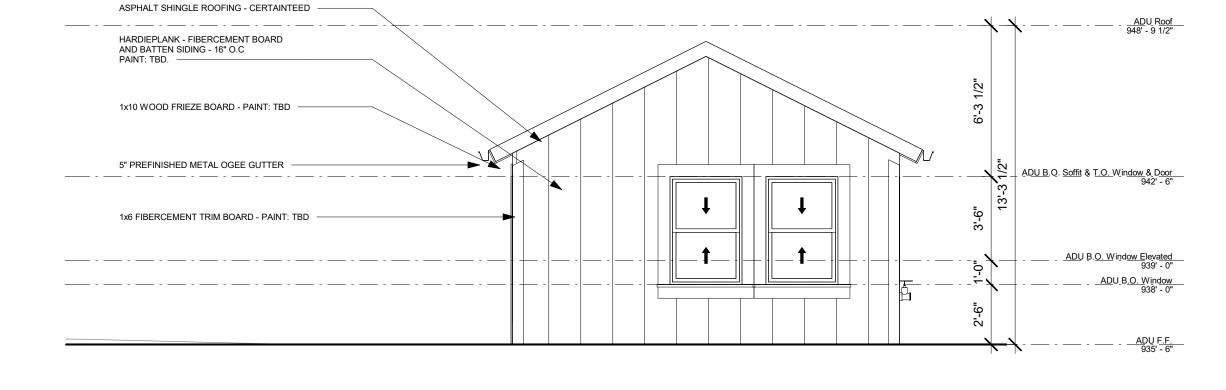

3 Proposed Rear Elevation - ADU 1/4" = 1'-0"

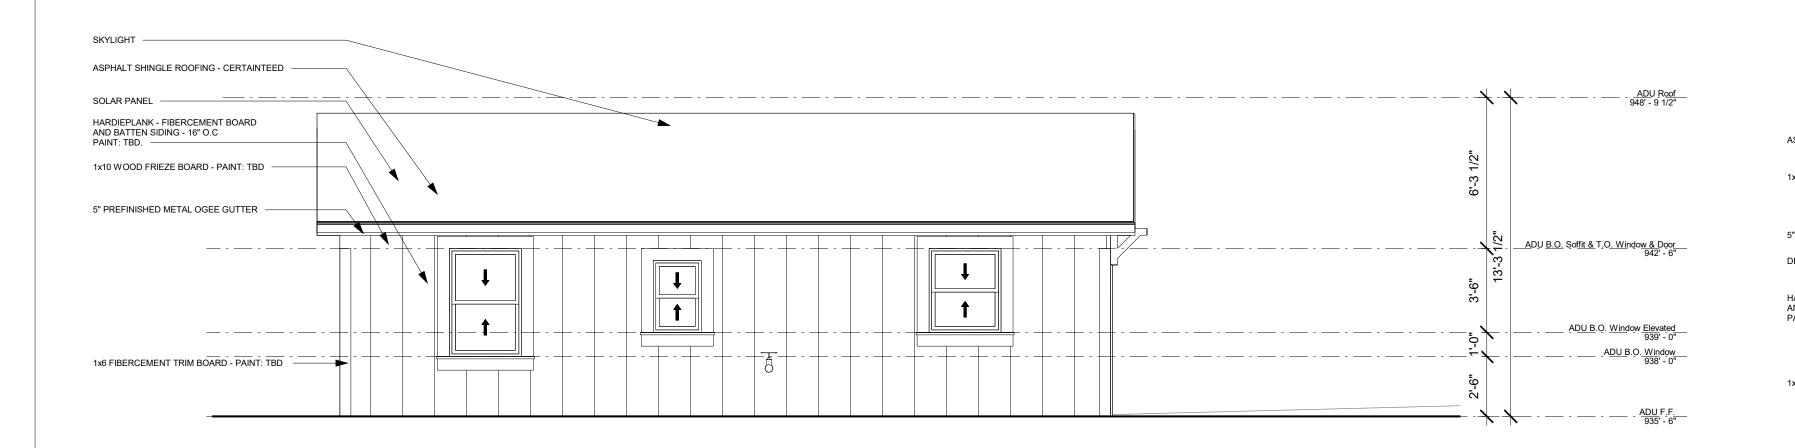

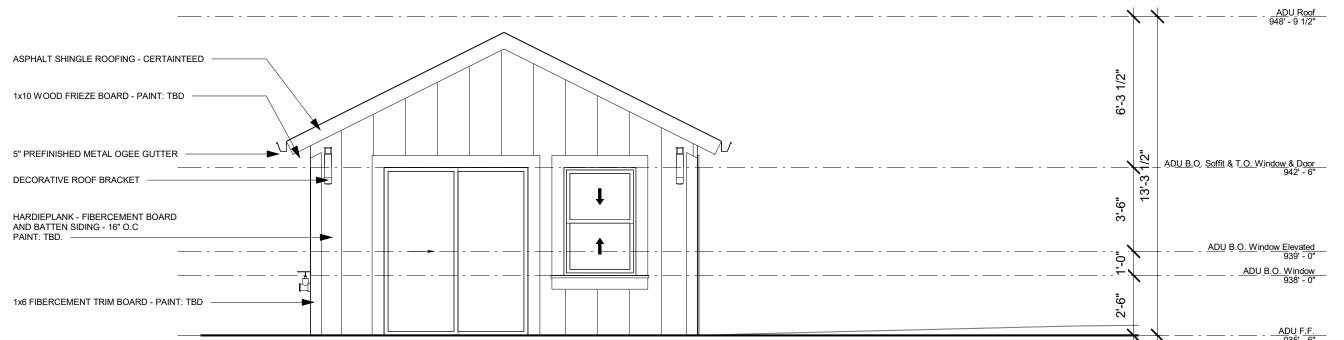



THE JETT STREET RESIDENCES

REVISION SCHEDULE

ARK DATE DESCRIPTION

ISSUANCE SCHEDULE

07/13/2022 PERMIT DOCS


MARK DATE DESCRIPTION


PROJECT ID 001


SHEET TITLE


Interior Elevations


SHEET NUMBER

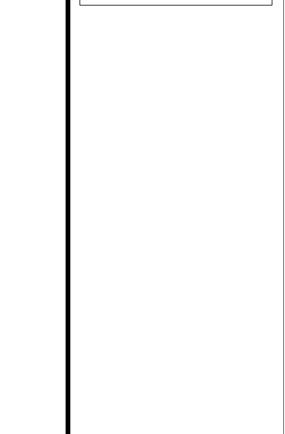

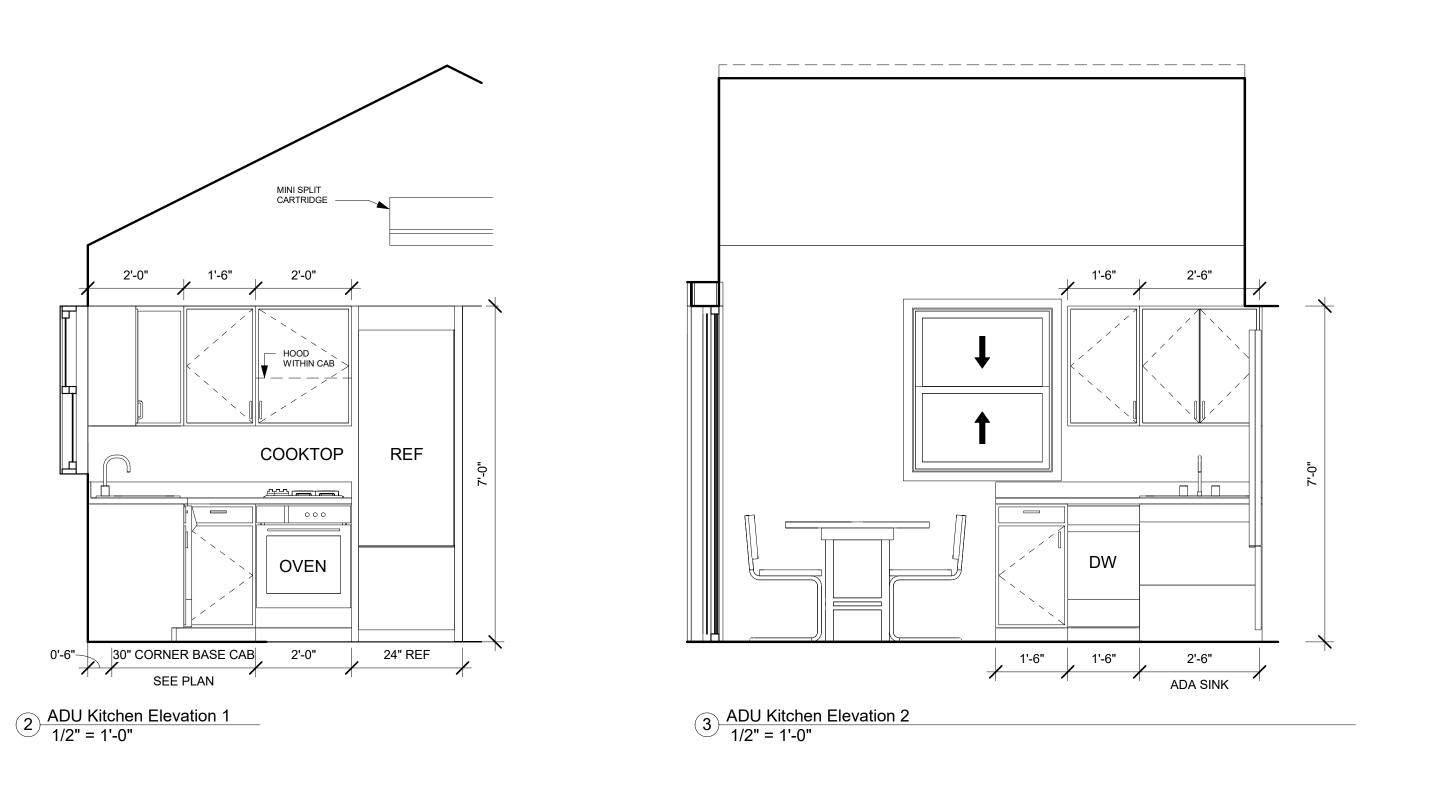

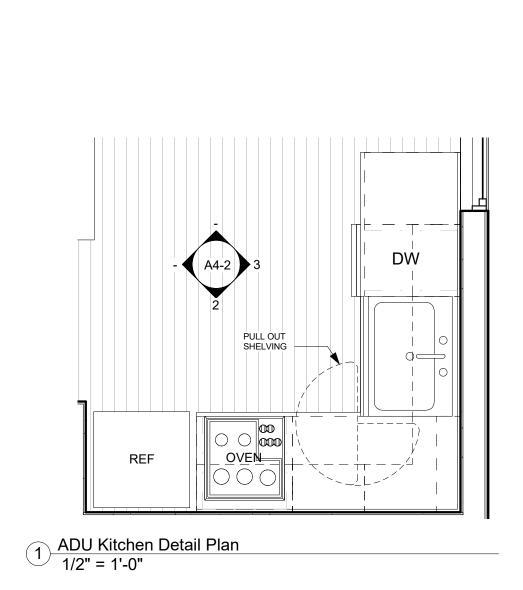

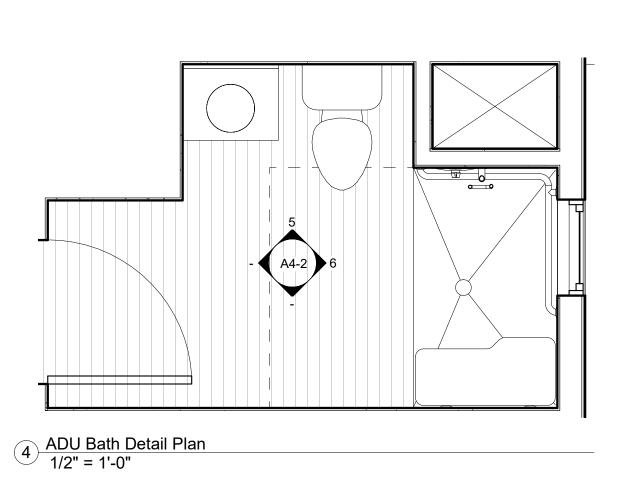

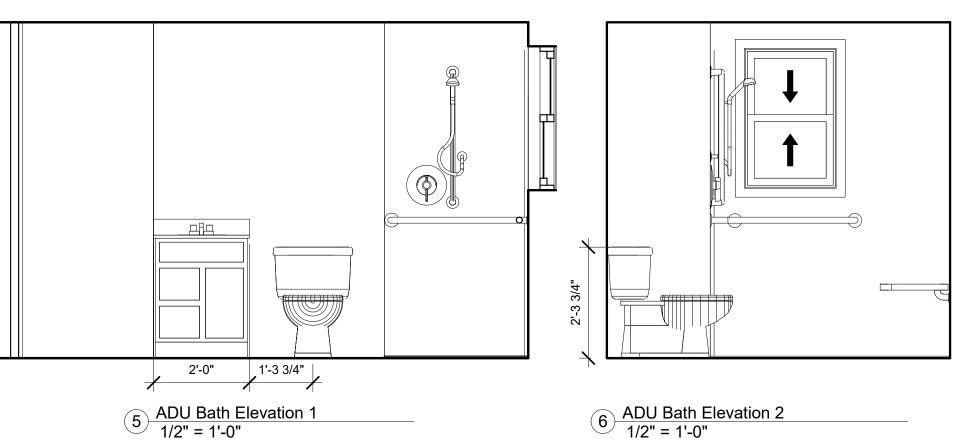

5 ADU Bath Elevation 1
1/2" = 1'-0" 6 ADU Bath Elevation 2 1/2" = 1'-0"

SHEET NUMBER

PROJECT ID

ISSUANCE SCHEDULE


REVISION SCHEDULE

MARK DATE DESCRIPTION

Interior

Elevations

07/13/2022 PERMIT DOCS

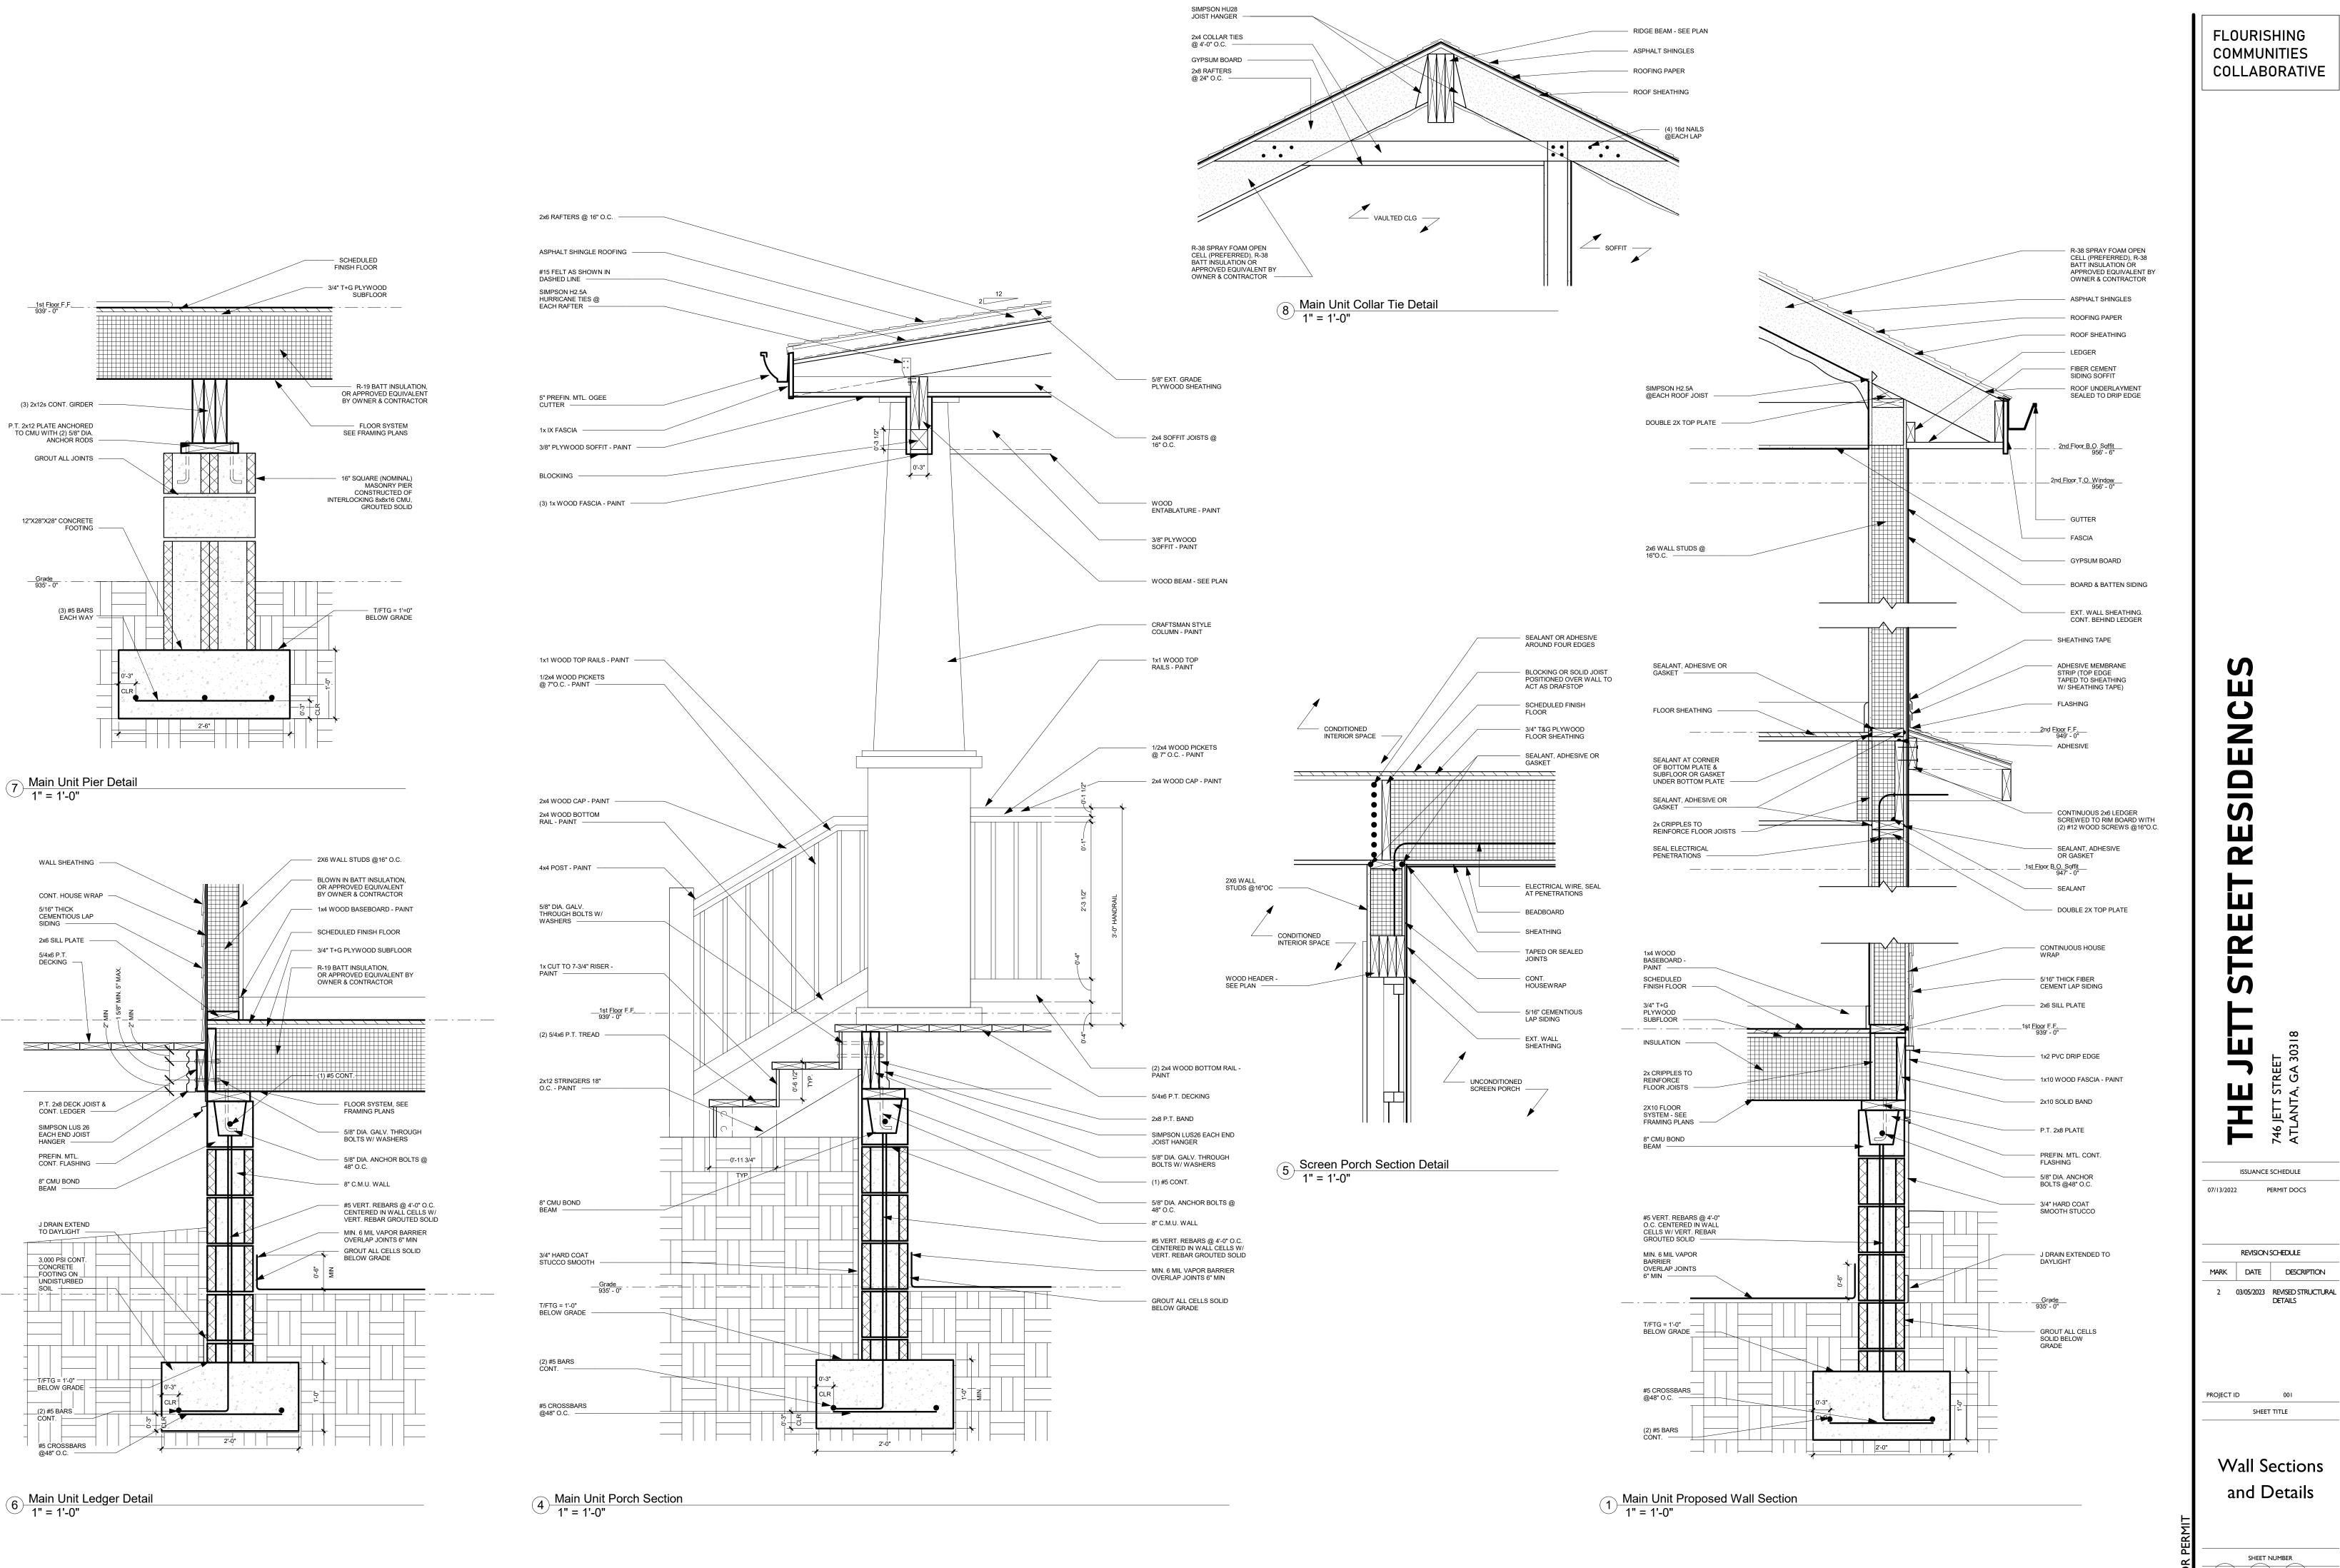

Wall Sections and Details

ISSUANCE SCHEDULE

REVISION SCHEDULE

MARK DATE DESCRIPTION

2 03/05/2023 REVISED STRUCTURAL DETAILS


Wall Sections


07/13/2022

PERMIT DOCS

FLOURISHING

COMMUNITIES COLLABORATIVE

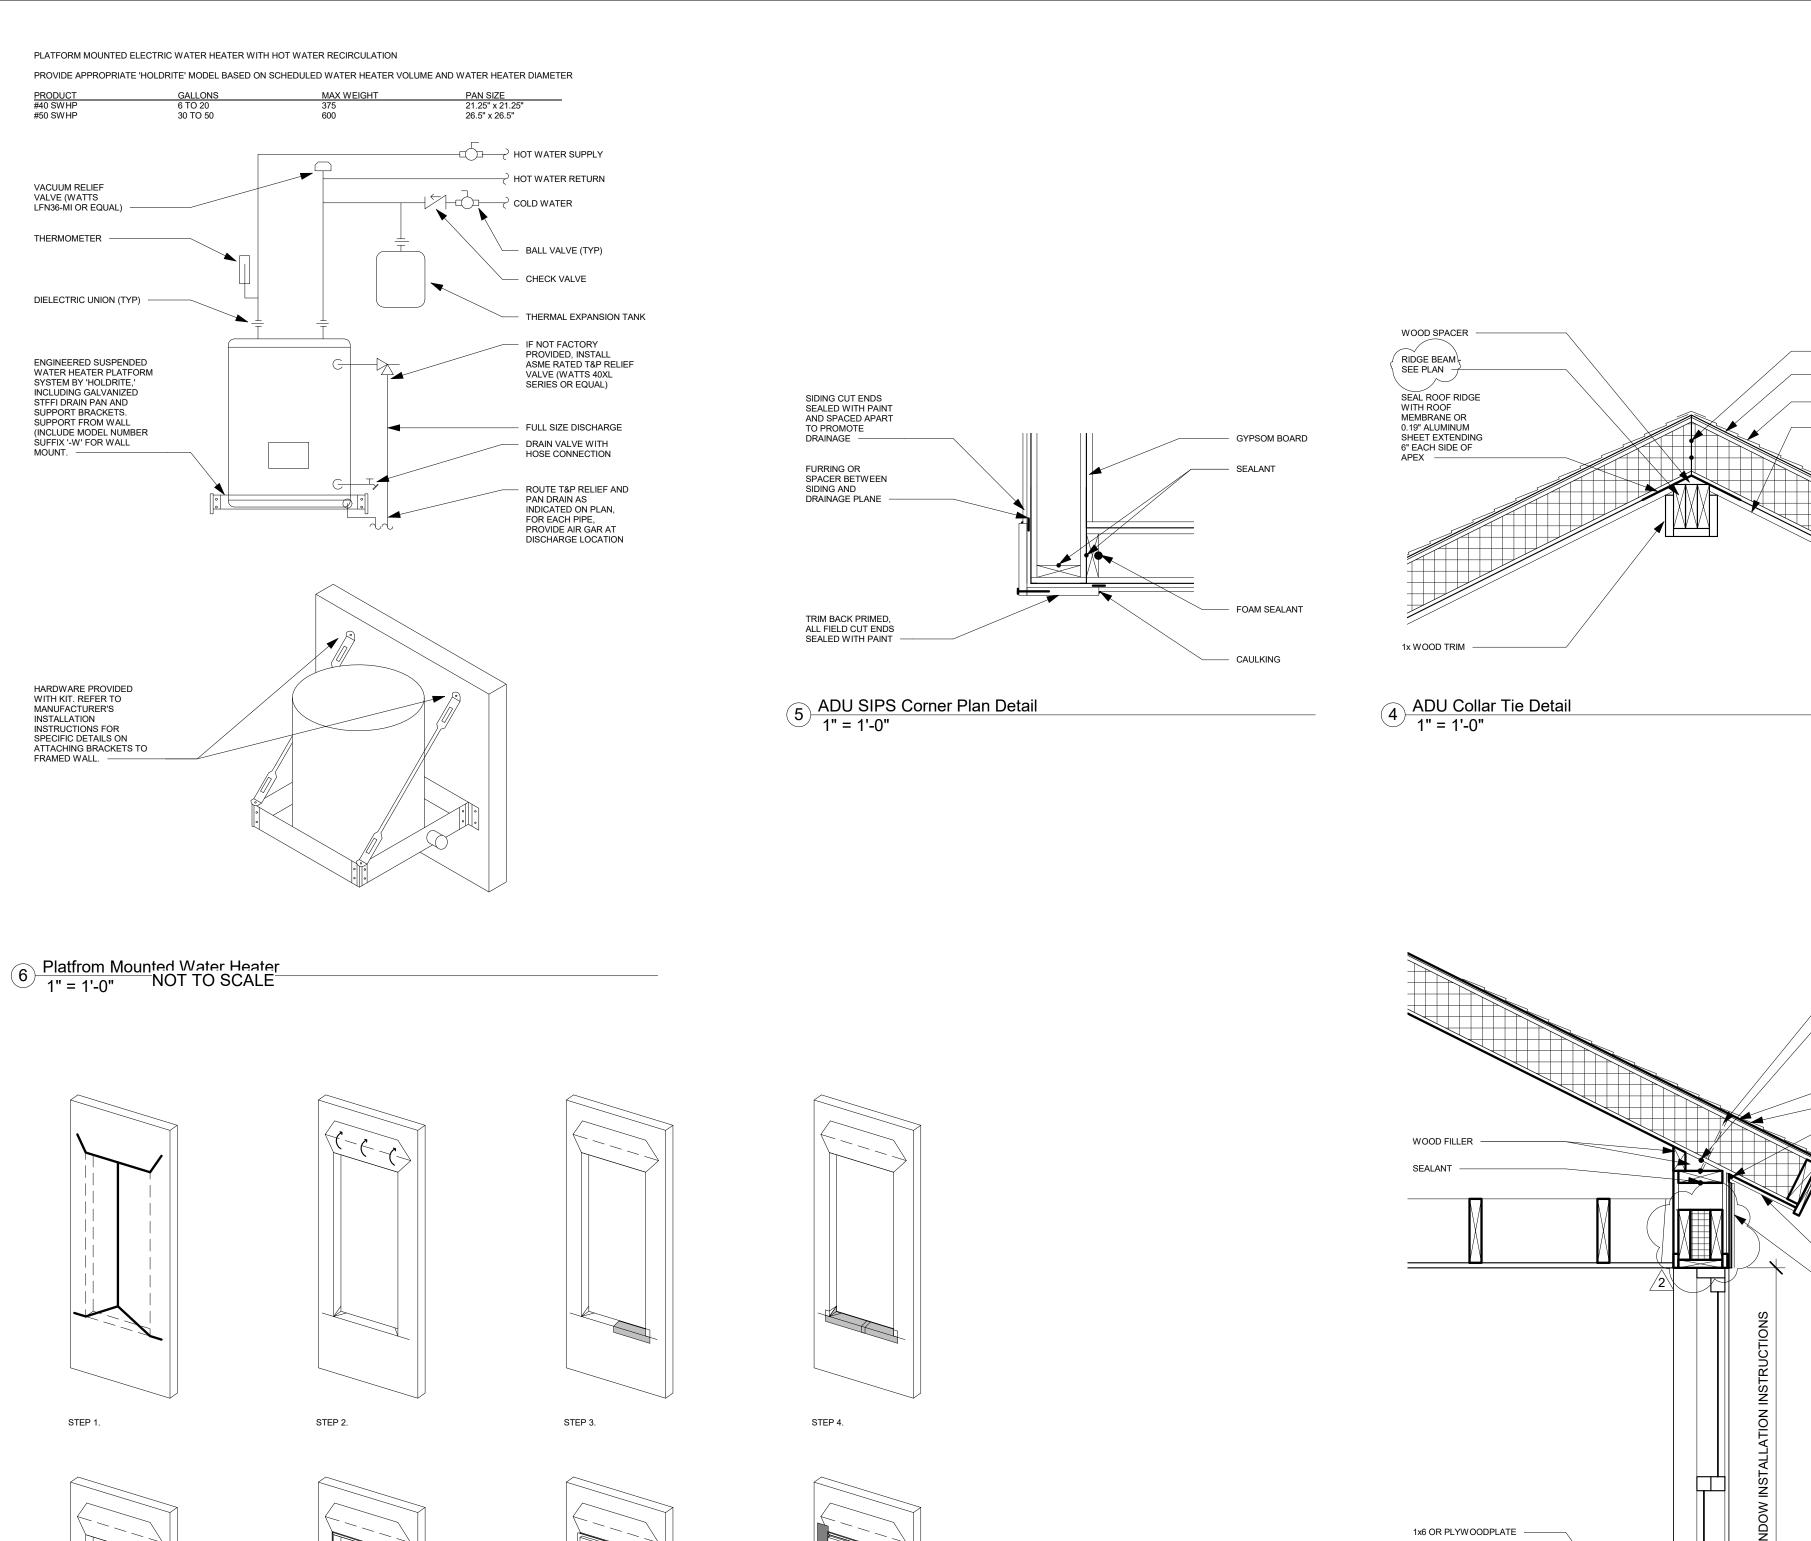

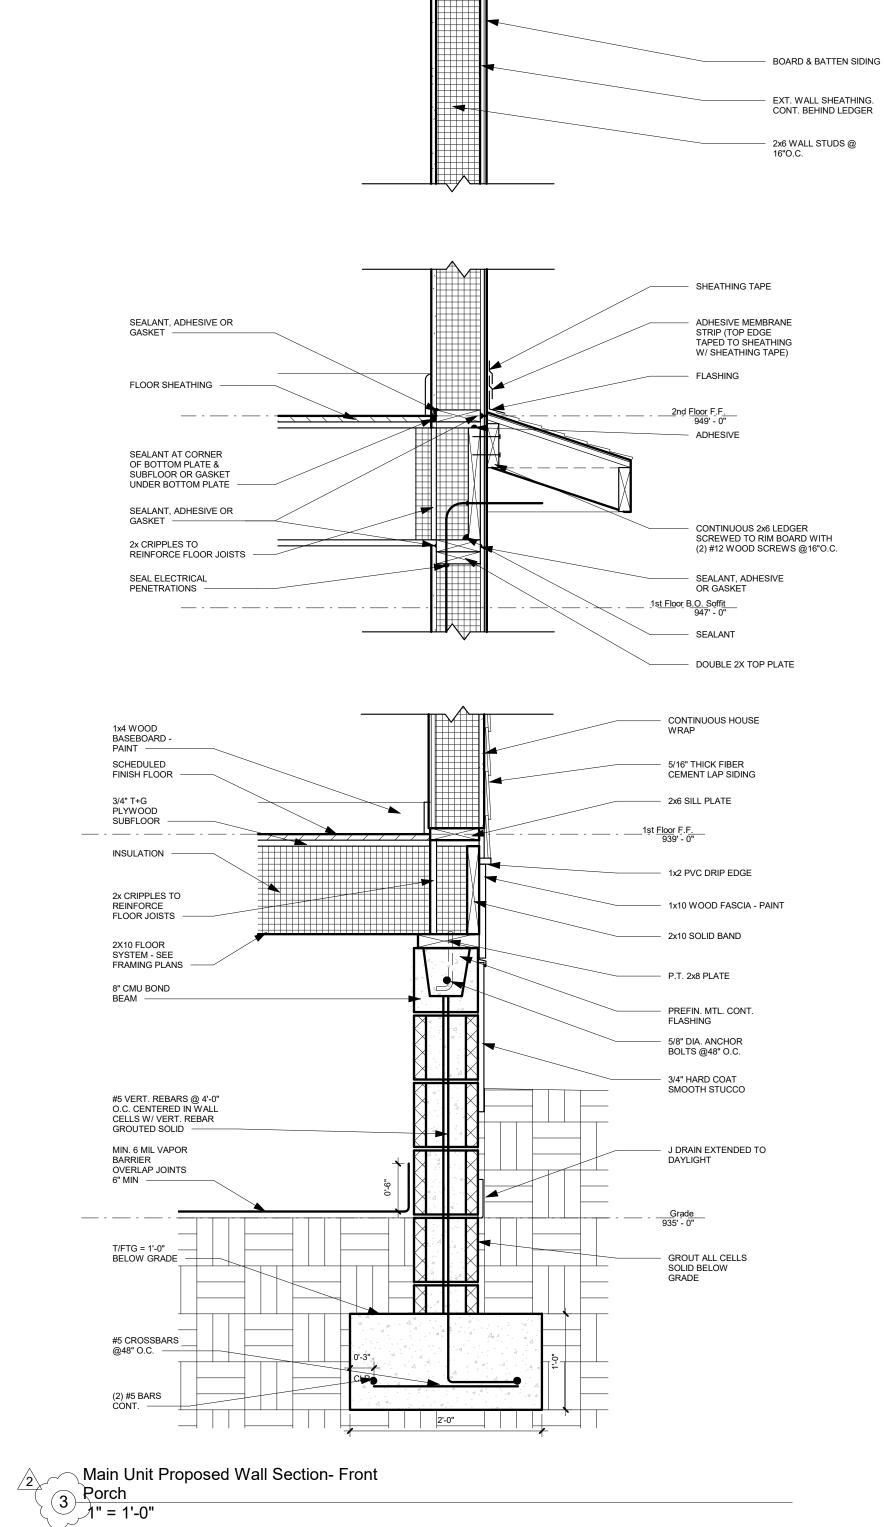

GYPSUM BOARD

R-38 SPRAY FOAM OPEN CELL (PREFERRED), R-38 BATT INSULATION OR


APPROVED EQUIVALENT BY OWNER & CONTRACTOR

ASPHALT SHINGLES

ROOF SHEATHING

SEALED TO DRIP EDGE


FIBER CEMENT

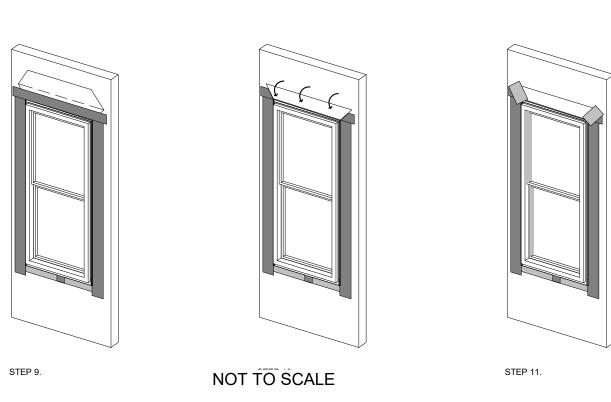

STEP 6.

STEP 5.

2 SIP Window Installation 1" = 1'-0"

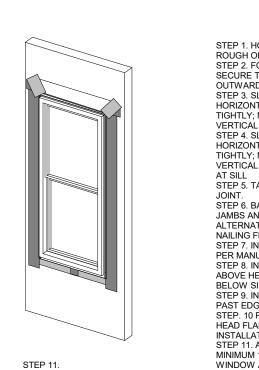

STEP 7.

STEP 1. HOUSEWRAP SIPS PANEL. CUT HOUSEWRAP AT ROUGH OPENING; NOTE CUTTING PATTERN.

STEP 2. FOLD HOUSEWRAP IN AT JAMBS AN SILL AND SECURE TIGHTLY; HEAD FLAP FOLDED UP AND OUTWARD

STEP 3. SLIP FIRST PIECE OF SILL PAN INTO
HORIZONTAL SLIT IN HOUSEWRAPS; PAN MUST FIT TIGHTLY; MECHANICALLY FASTEN AT EXTERIOR
VERTICAL FACE ONLY
STEP 4. SLIP SECOND PIECE OF SILL PAN INTO
HORIZONTAL SLIT IN HOUSEWRAP; PAN MUST FIT TIGHTLY; MECHANICALLY FASTEN AT EXTERIOR
VERTICAL FACE ONLY; ENSURE A MINIMUM 3" OVERLAP AT SILL
STEP 5. TAPE OR FLASH SILL PAN AT JAMBS AND SILL
JOINT.
STEP 6. BACK-CAULK WINDOW; APPLY SEALANT AT
JAMBS AND HEAD; DO NOT APPLY TO SILL;
ALTERNATIVELY, CAULK CAN BE APPLIED TO WINDOW
NAILING FLANGE PRIOR TO INSTALLATION.
STEP 7. INSTALL WINDOW PLUMB, LEVEL AND SQUARE
PER MANUFACTURER'S INSTRUCTIONS.
STEP 8. INSTALL JAMB FLASHING; EXTEND MINIMUM 1"
ABOVE HEAD NAILING FLANGE.
STEP 9. INSTALL HEAD FLASHING; EXTEND MINIMUM 2"
PAST EDGE OF JAMB FLASHING.
STEP. 10 FOLD HOUSEWRAP DOWN AT HEAD; ENSURE
HEAD FLAP HAS NOT BEEN DAMAGED DURING
INSTALLATION PROCESS.
STEP 11. APPLY CORNER PATCHES AT HEAD; EXTEND
MINIMUM 1" BEYOND CUT IN HOUSEWRAP; AIR SEAL
WINDOW AROUND ENTIRE PERIMETER ON THE
INTERIOR WITH SEALANT OR NON-EXPANDING FOAM.

STEP 8.

1 ADU Proposed Wall Section
1" = 1'-0"

2'-0"

FILLER PIECE AT

2x4 STRUCTURAL SPLINES TO SUPPORT WINDOW BOX BEAM

BEARING PLATE TO FACILITATE "CANTILEVER"

ELECTRICAL SERVICE -

3/4" PINE SPACER -

_CONCRETE ____ GRADE BEAM -

POLYETHYLENE VAPOR — BARRIER EXTENDED

UNDER GRADE BEAM
WHERE IT ALSO ACTS AS

A CAPILLARY BREAK -

4" CONCRETE SLAB —

4" GRANULAR CAPILLARY

BREAK AND DRAINAGE PAD

SILL GASKET

BASEBOARD -

and Details


OF DETAILS


SHEET NUMBER

A F OF

A5-2

PROJECT ID

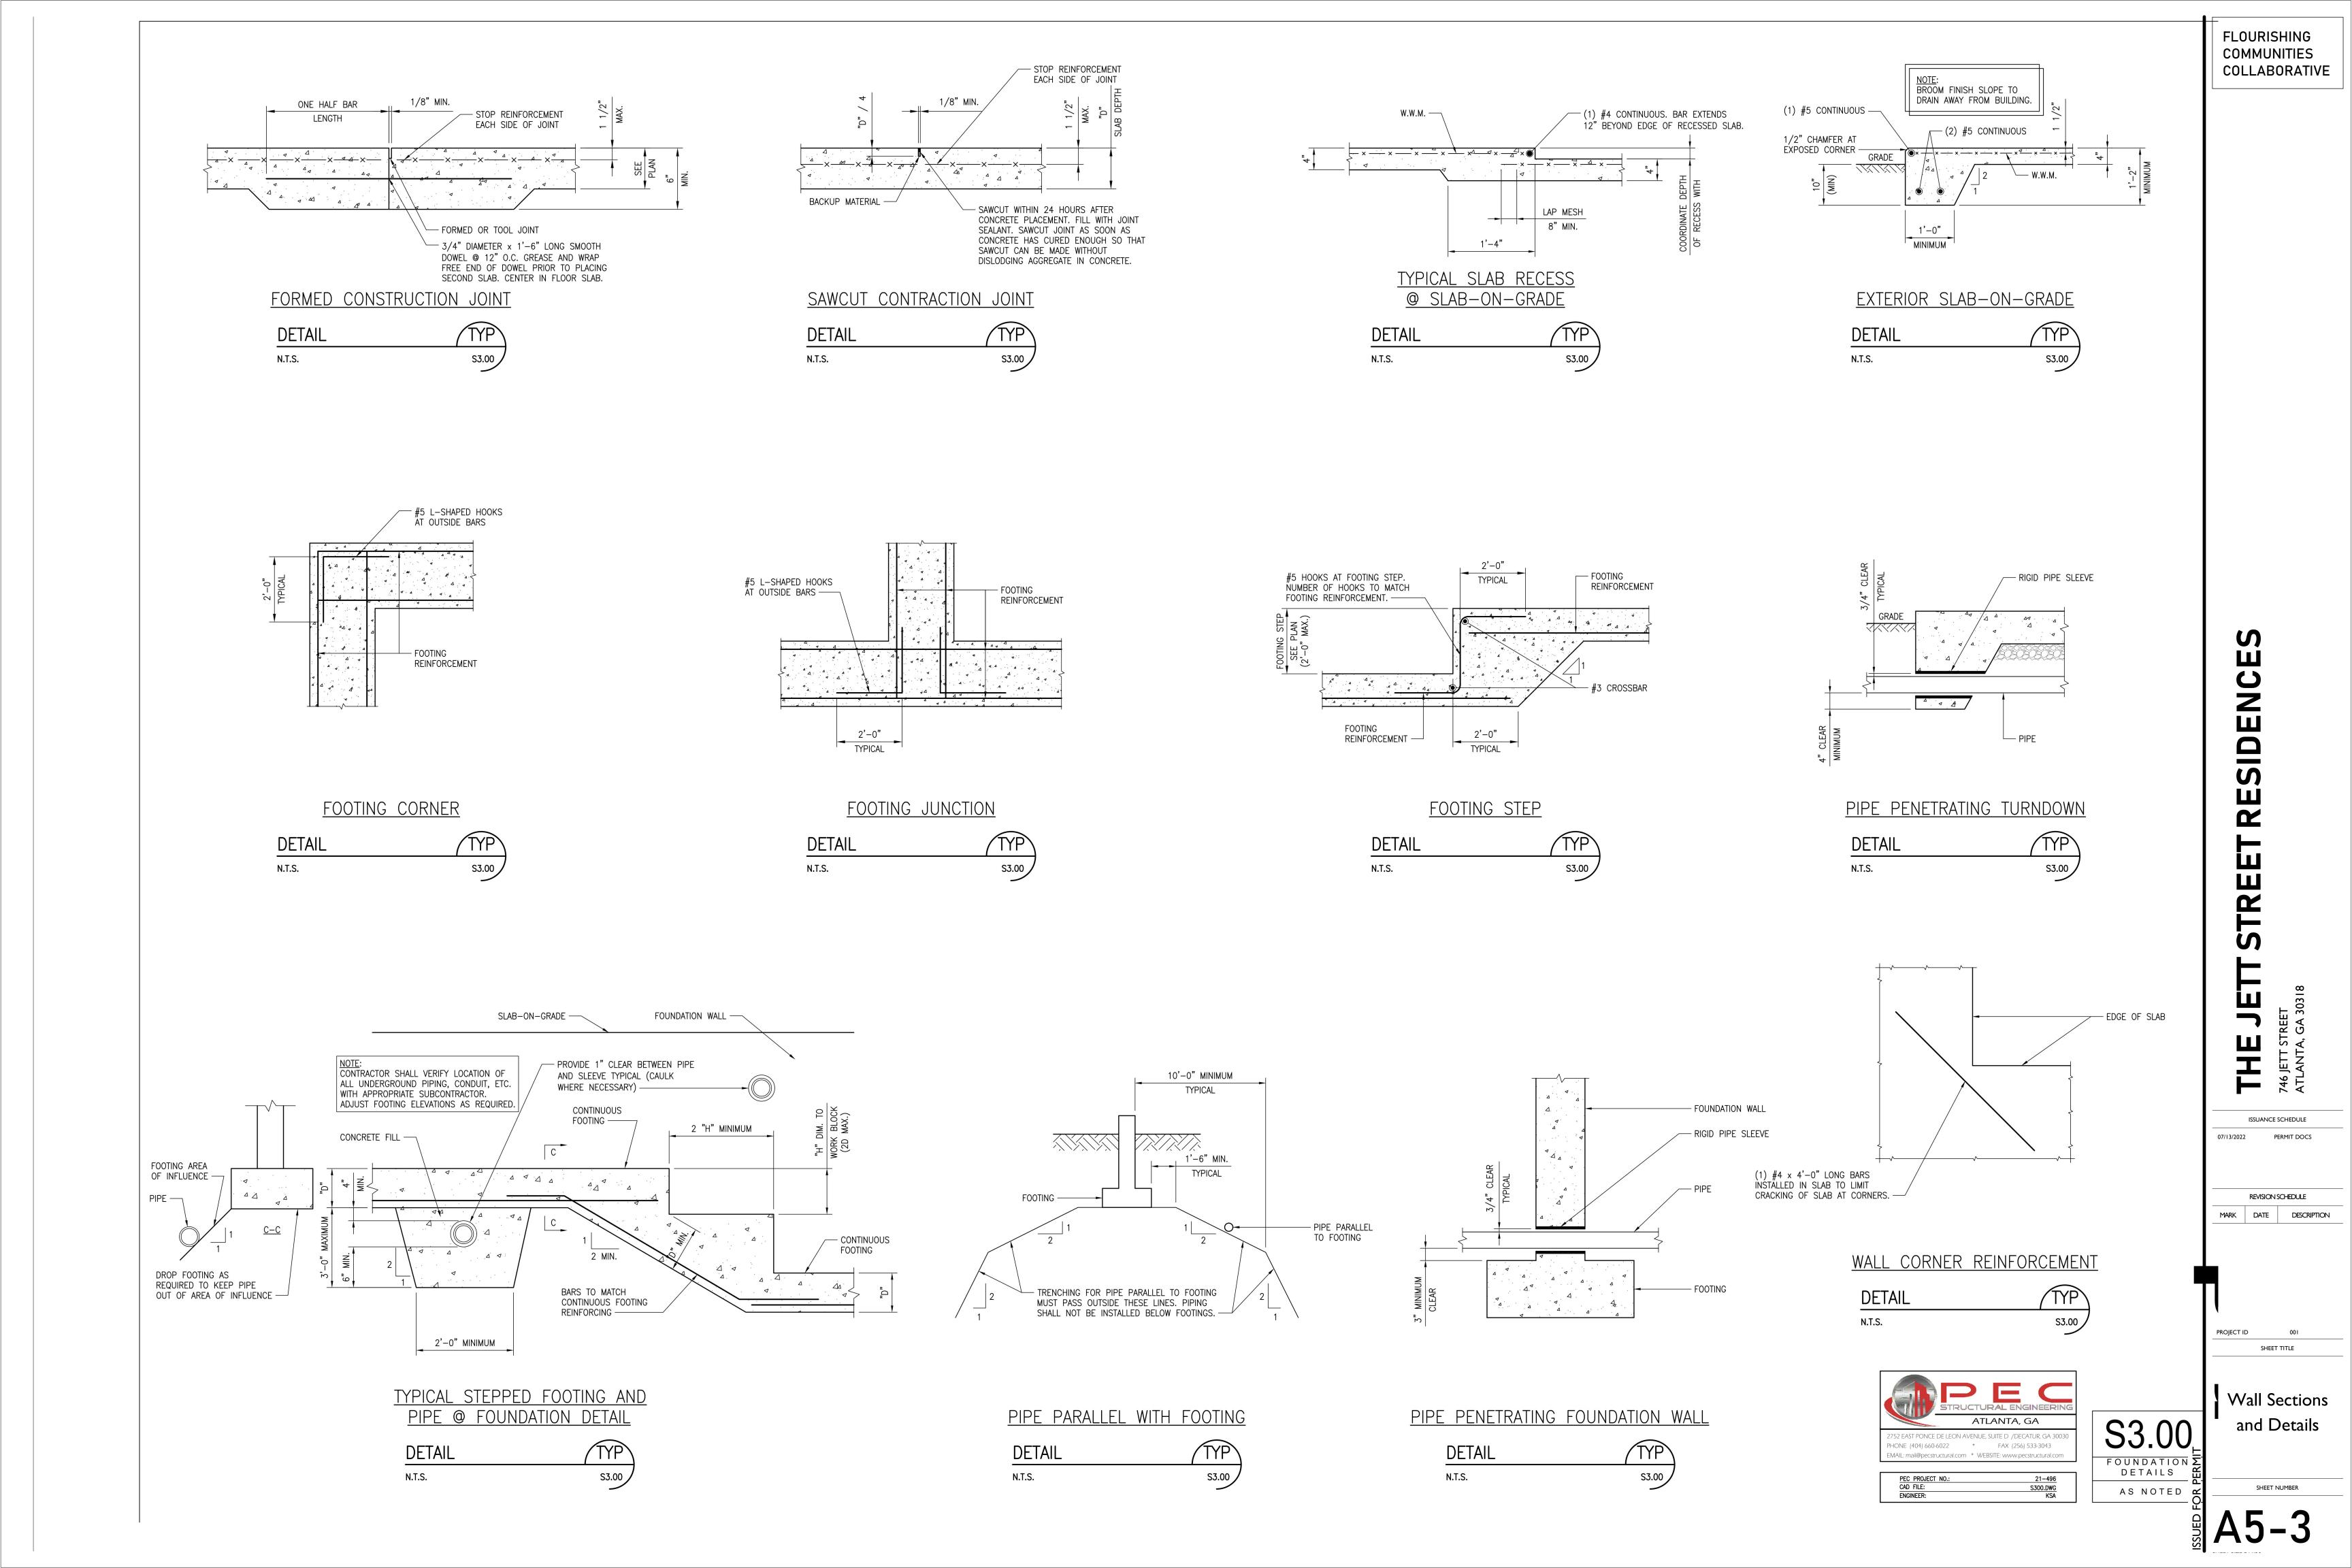

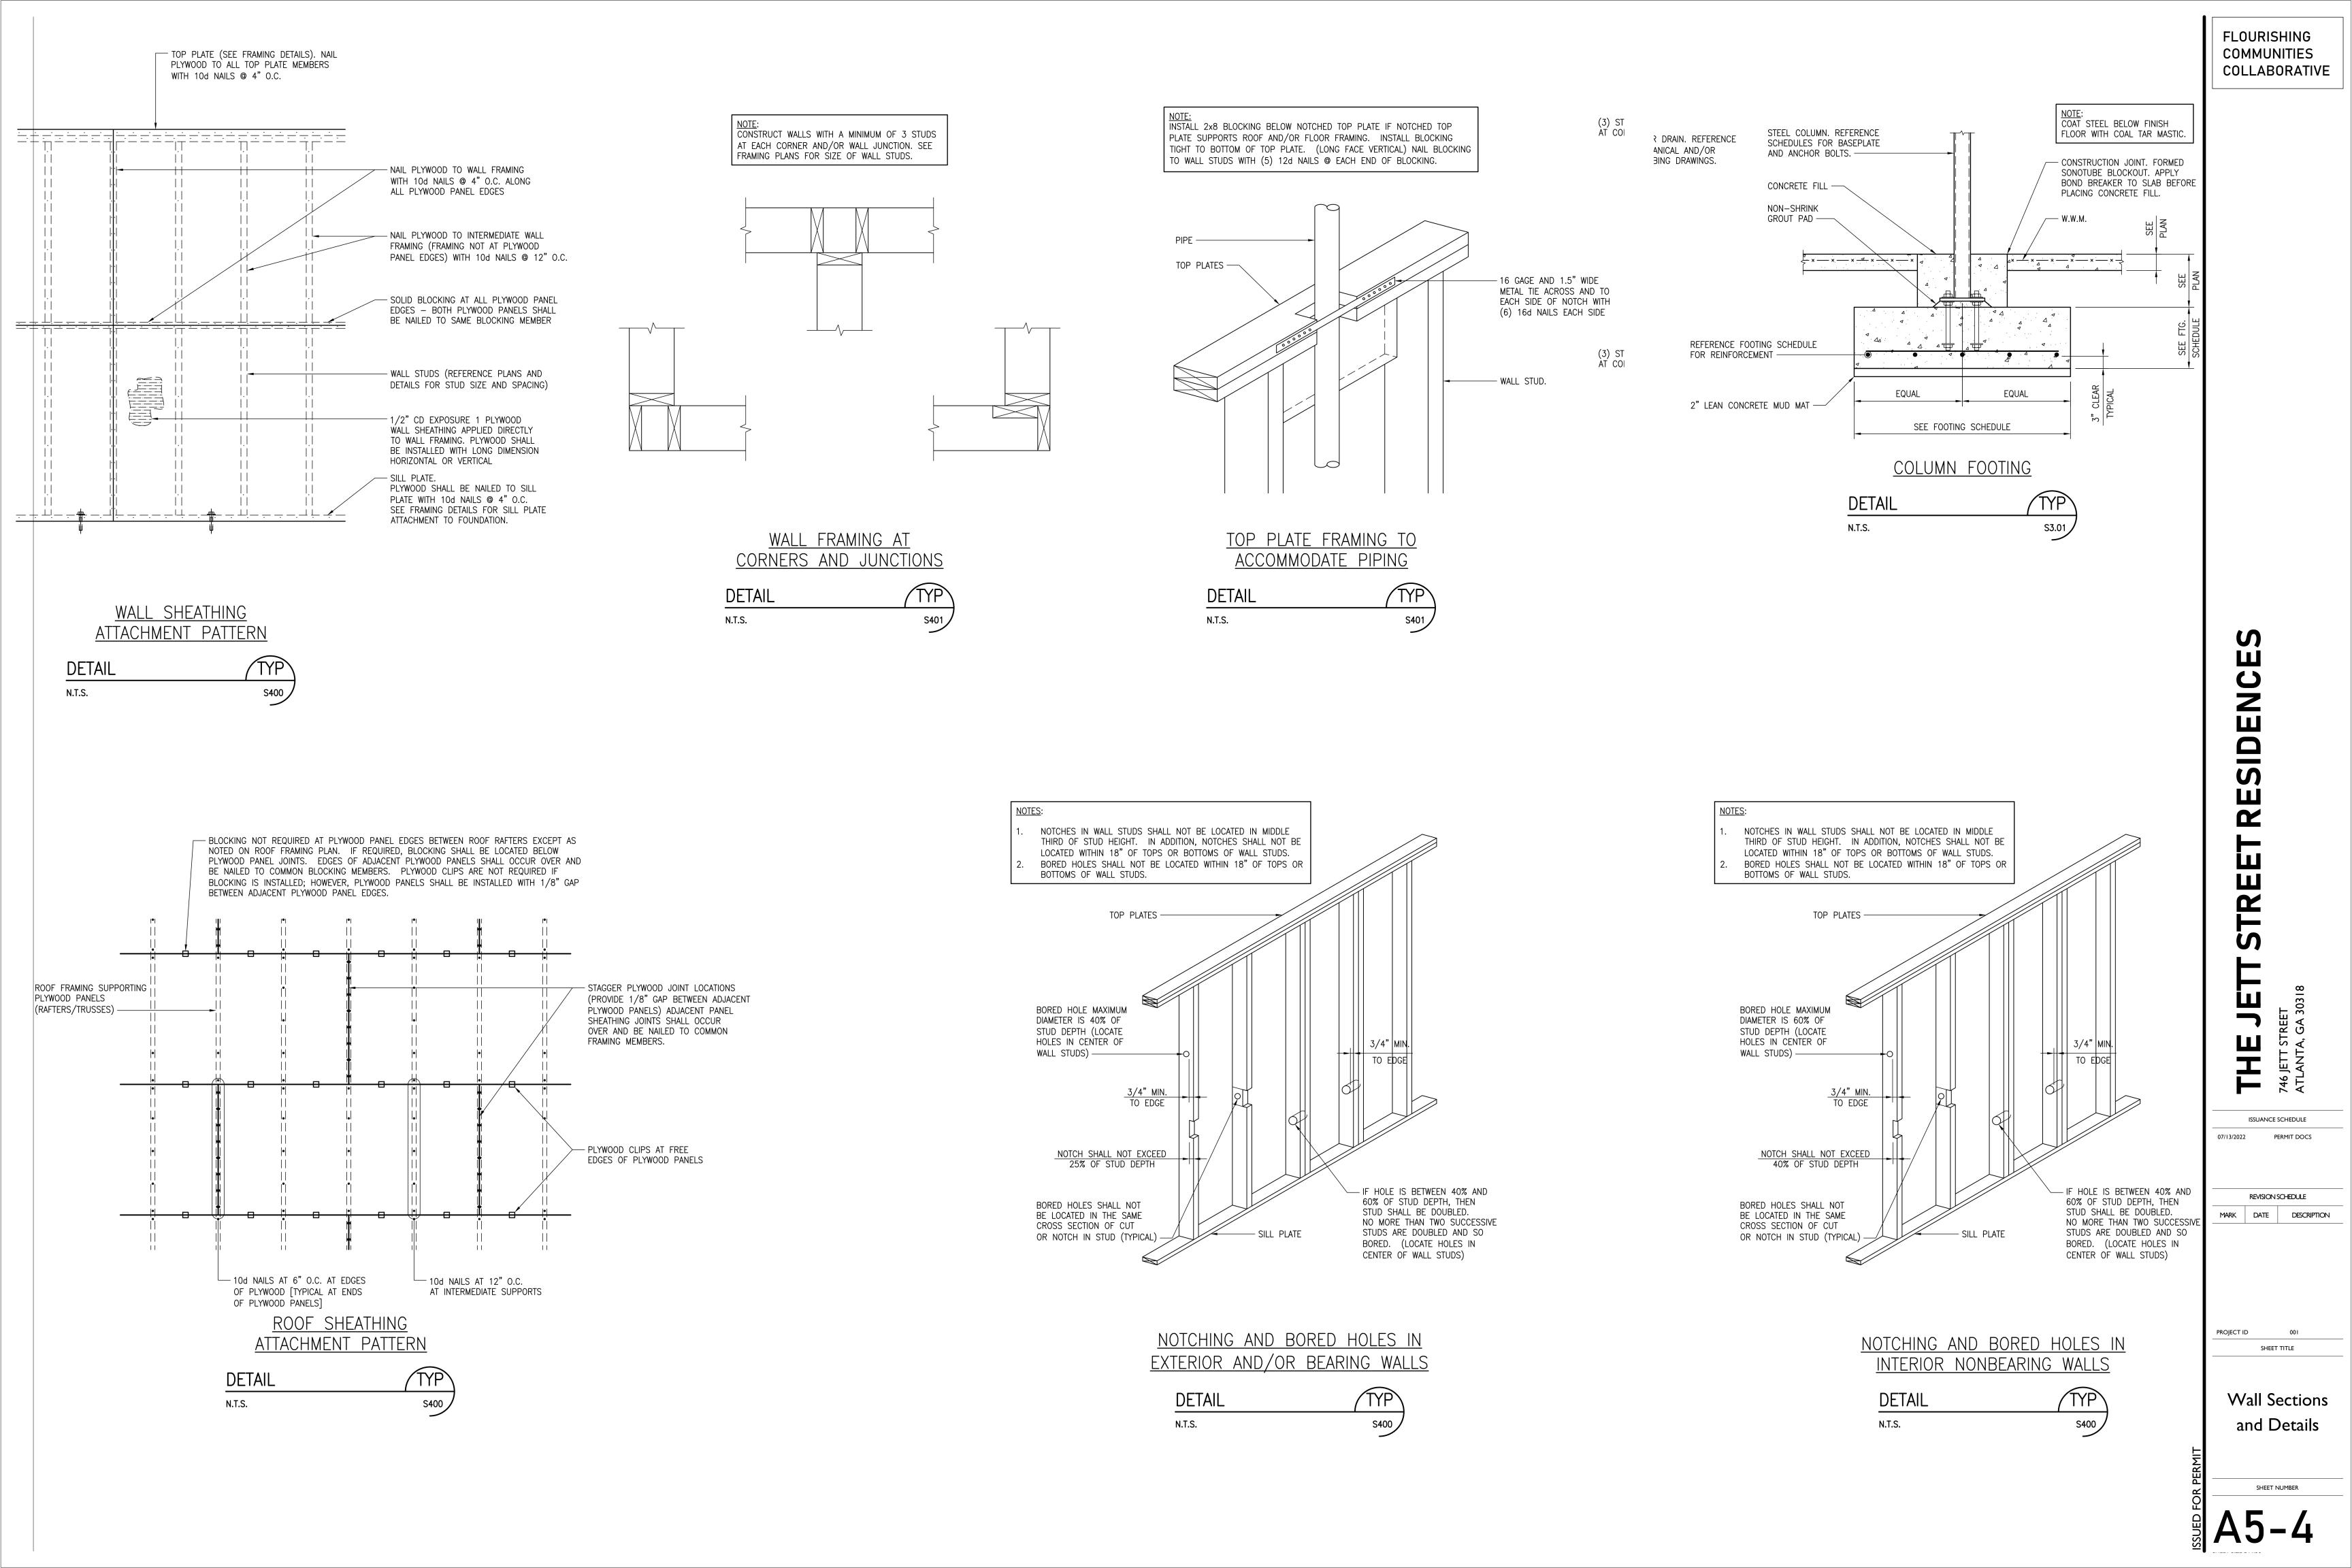

THE JETT STREET RESIDENCES

ISSUANCE SCHEDULE

07/13/2022 PERMIT DOCS

REVISION SCHEDULE

REVISION SCHEDULE

MARK DATE DESCRIPTION

PROJECT ID 001

SHEET TITLE

Stair Sections

SHEET NUMBER

A5-5